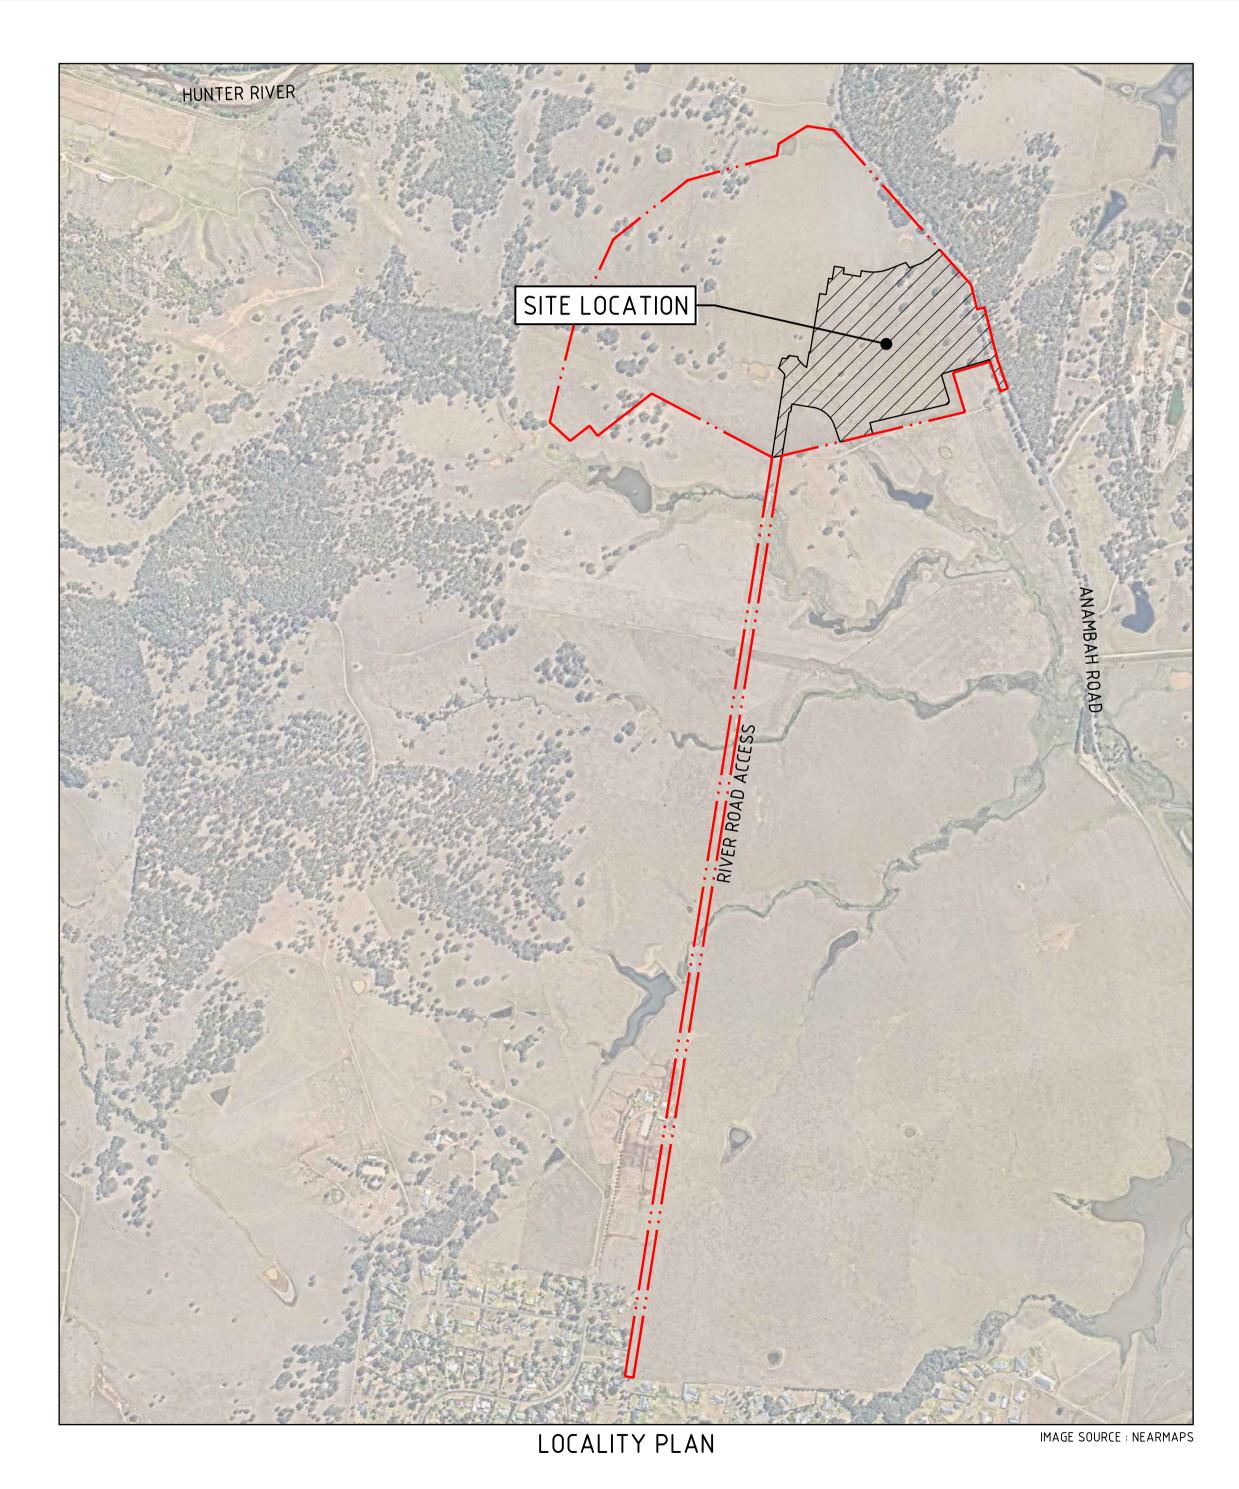
PROPOSED SUBDIVISION, 559 ANAMBAH ROAD GOSFORTH NSW 2320

STAGE 1 DEVELOPMENT APPLICATION CIVIL ENGINEERING PACKAGE



DRAWING LIST


DRAWINGTITLE COVER SHEET, DRAWING SCHEDULE AND LOCALITY PLAN GENERAL ARRANGEMENT PLAN STAGE 1 CLEARING PLAN CIVIL WORKS PLAN - SHEET 2 CIVIL WORKS PLAN - SHEET 3 CIVIL WORKS PLAN - SHEET 4 ROAD AND PATH PLAN TYPICAL SECTIONS - SHEET 1 DA1-C05.22 TYPICAL SECTIONS - SHEET 2 DA1-C05.26 TYPICAL CIVIL DETAILS ROAD LONGITUDINAL SECTIONS - SHEET 1 DA1-C05.32 ROAD LONGITUDINAL SECTIONS - SHEET 2 DA1-C05.33 ROAD LONGITUDINAL SECTIONS - SHEET 3 DA1-C05.34 ROAD LONGITUDINAL SECTIONS - SHEET 4 DA1-C05.35 ROAD LONGITUDINAL SECTIONS - SHEET 5 ROAD LONGITUDINAL SECTIONS - SHEET 6 DA1-C05.37 ROAD LONGITUDINAL SECTIONS - SHEET 7 CONCEPT BULK EARTHWORKS PLAN EROSION AND SEDIMENT CONTROL PLAN DA1-C07.11 EROSION AND SEDIMENT CONTROL NOTES DA1-C07.12 EROSION AND SEDIMENT CONTROL DETAILS CONCEPT CIVIL WORKS PLAN RIVER ROAD - SHEET 1 CONCEPT CIVIL WORKS PLAN RIVER ROAD - SHEET 2 CONCEPT CIVIL WORKS PLAN RIVER ROAD - SHEET 3 DA1-C08.21 ROAD TYPICAL SECTIONS RIVER ROAD ROAD LONGITUDINAL SECTIONS RIVER ROAD - SHEET 1 ROAD LONGITUDINAL SECTIONS RIVER ROAD - SHEET 2 ROAD LONGITUDINAL SECTIONS RIVER ROAD - SHEET 3



NOT FOR CONSTRUCTION

REVISION	DESCRIPTION	1220FD	VERID	APP	DATE	LL
Α	DRAFT ISSUE	JS	-	AK	16.08.24	
В	ISSUED FOR APPROVAL	JS	LM	AK	22.08.24	
С	REISSUED FOR APPROVAL	JS	LM	AK	28.08.24	
D	DRAFT ISSUE	JS	-	AK	16.05.25	
Е	REISSUED FOR APPROVAL	JS	LM	AK	30.05.25	
						Į



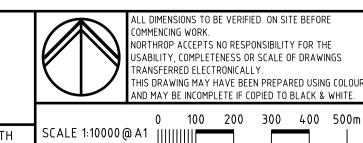



Level 1, 215 Pacific Hwy, Charlestown NSW 2290 Ph (02) 4943 1777 Email newcastle@northrop.com.au ABN 81 094 433 100

ROAD LONGITUDINAL SECTIONS RIVER ROAD - SHEET 4

PROPOSED SUBDIVISION **559 ANAMBAH ROAD GOSFORTH NSW 2320**

STAGE 1 DA

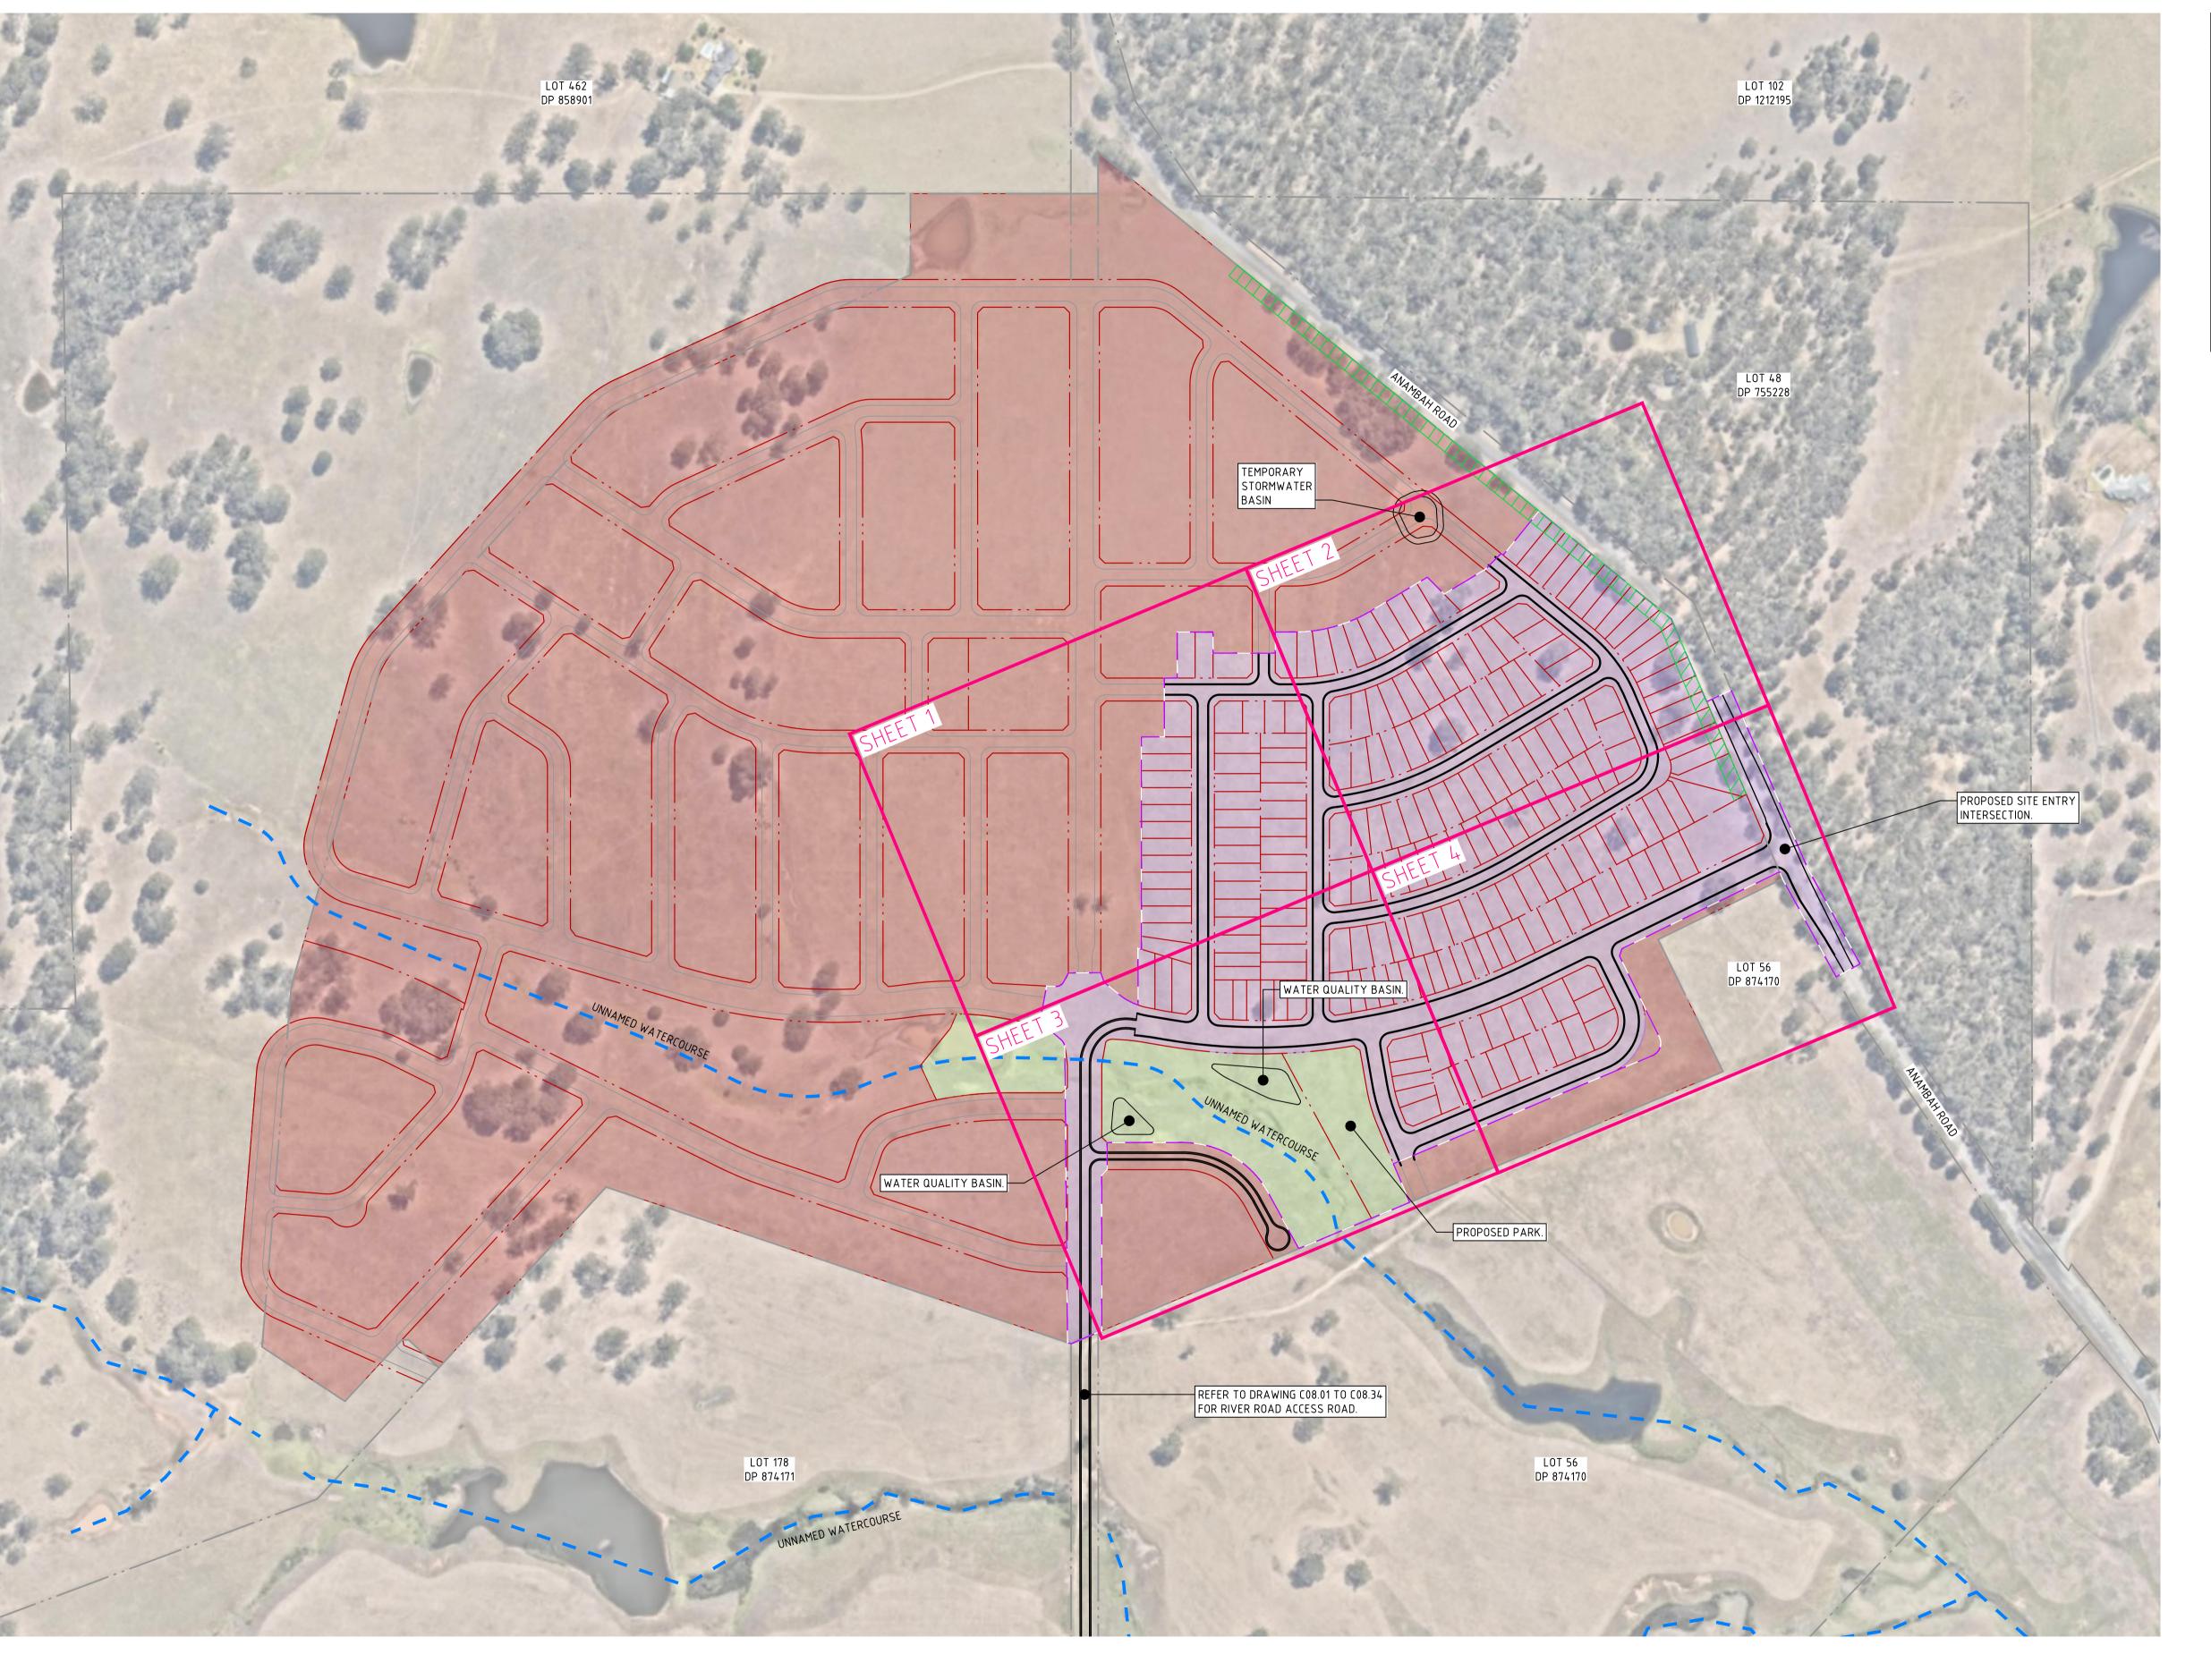
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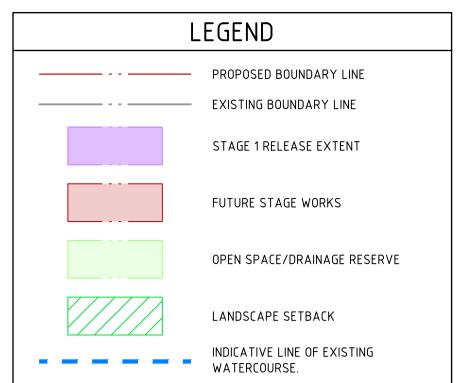
CIVIL ENGINEERING PACKAGE NL222055-01 DA1-C01.01 AND LOCALITY PLAN

DRAWING SHEET SIZE = A1

UNLESS VERIFICATION SIGNATURE HAS BEEN ADDE

NORTHROP CONSULTING ENGINEERS PTY LTD








REVISION	DESCRIPTION	ISSUED	VER'D	APP'D	DATE	CL
Α	DRAFT ISSUE	JS	-	AK	07.08.24	
В	DRAFT ISSUE	JS	ı	AK	16.08.24	
С	ISSUED FOR APPROVAL	JS	LM	AK	22.08.24	
D	REISSUED FOR APPROVAL	JS	LM	AK	28.08.24	
Е	DRAFT ISSUE	JS	1	AK	16.05.25	
F	REISSUED FOR APPROVAL	JS	LM	AK	30.05.25	Į

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PROPOSED SUBDIVISION 559 ANAMBAH ROAD GOSFORTH NSW 2320

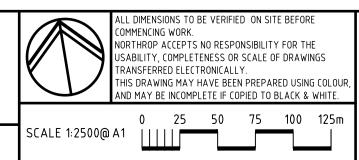STAGE 1 DA

CIVIL ENGINEERING PACKAGE
ROAD
W 2320
GENERAL ARRANGEMENT PLAN

JOB NUMBER

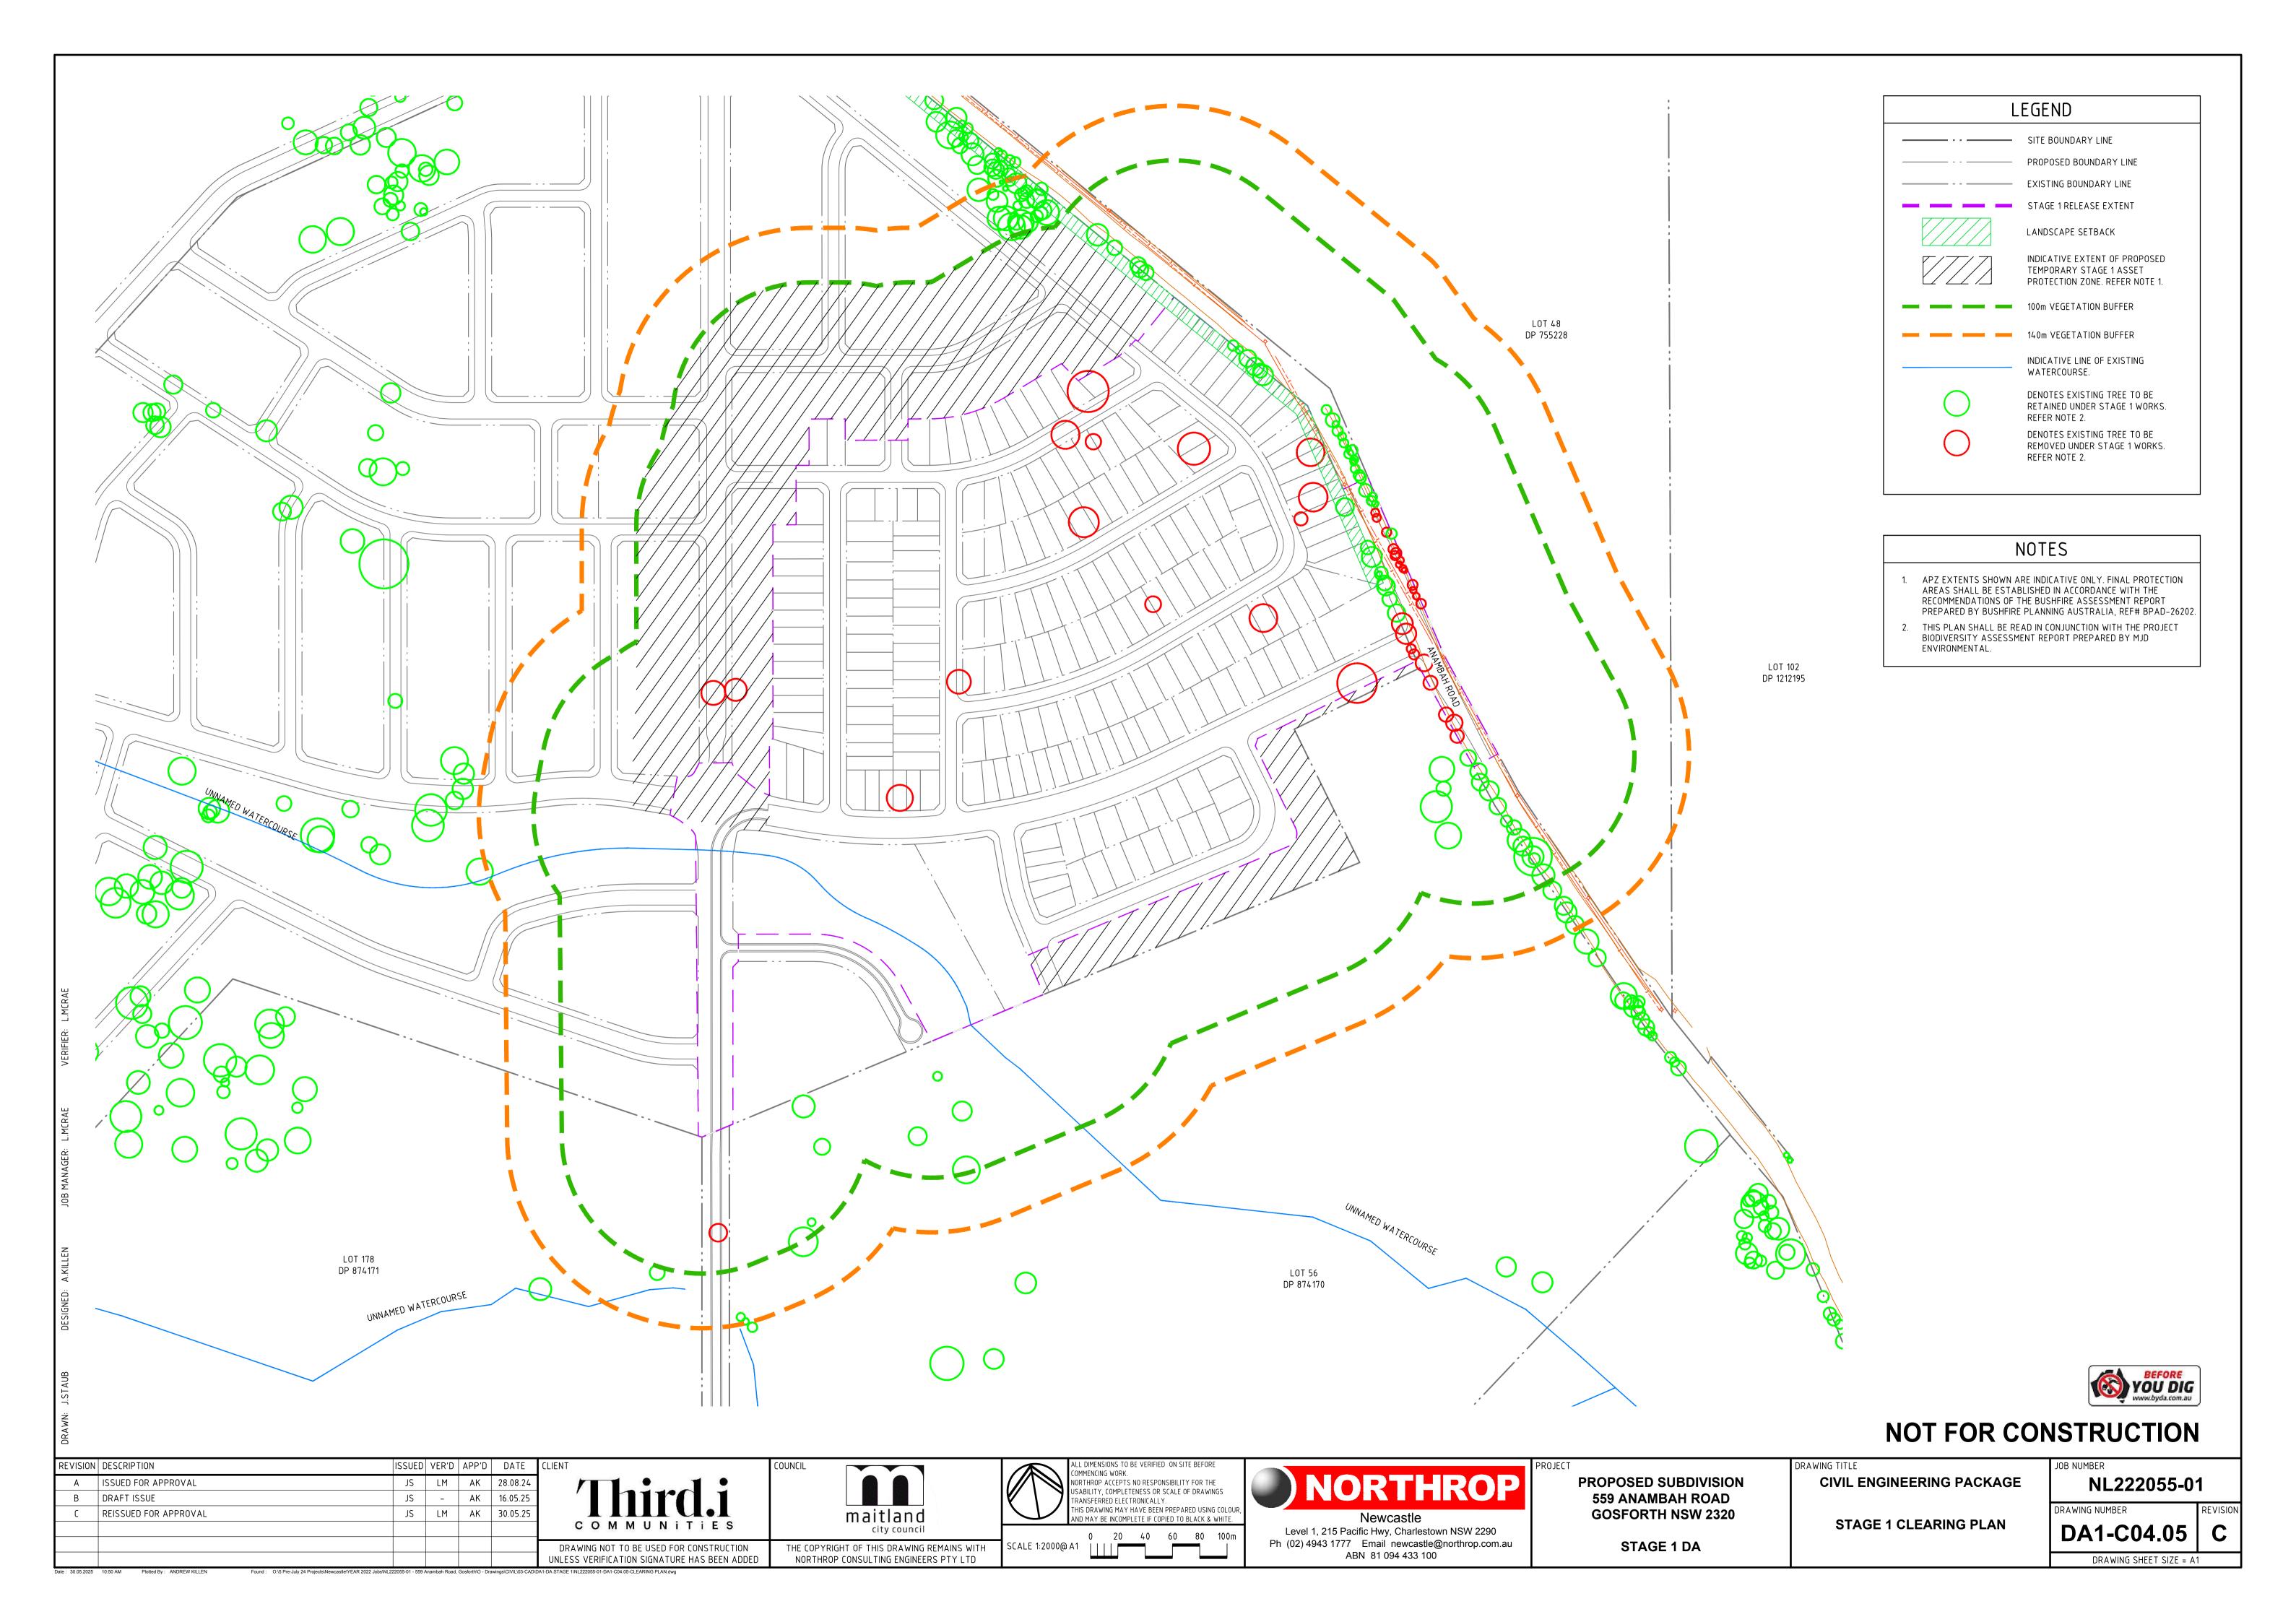
NL222055-01

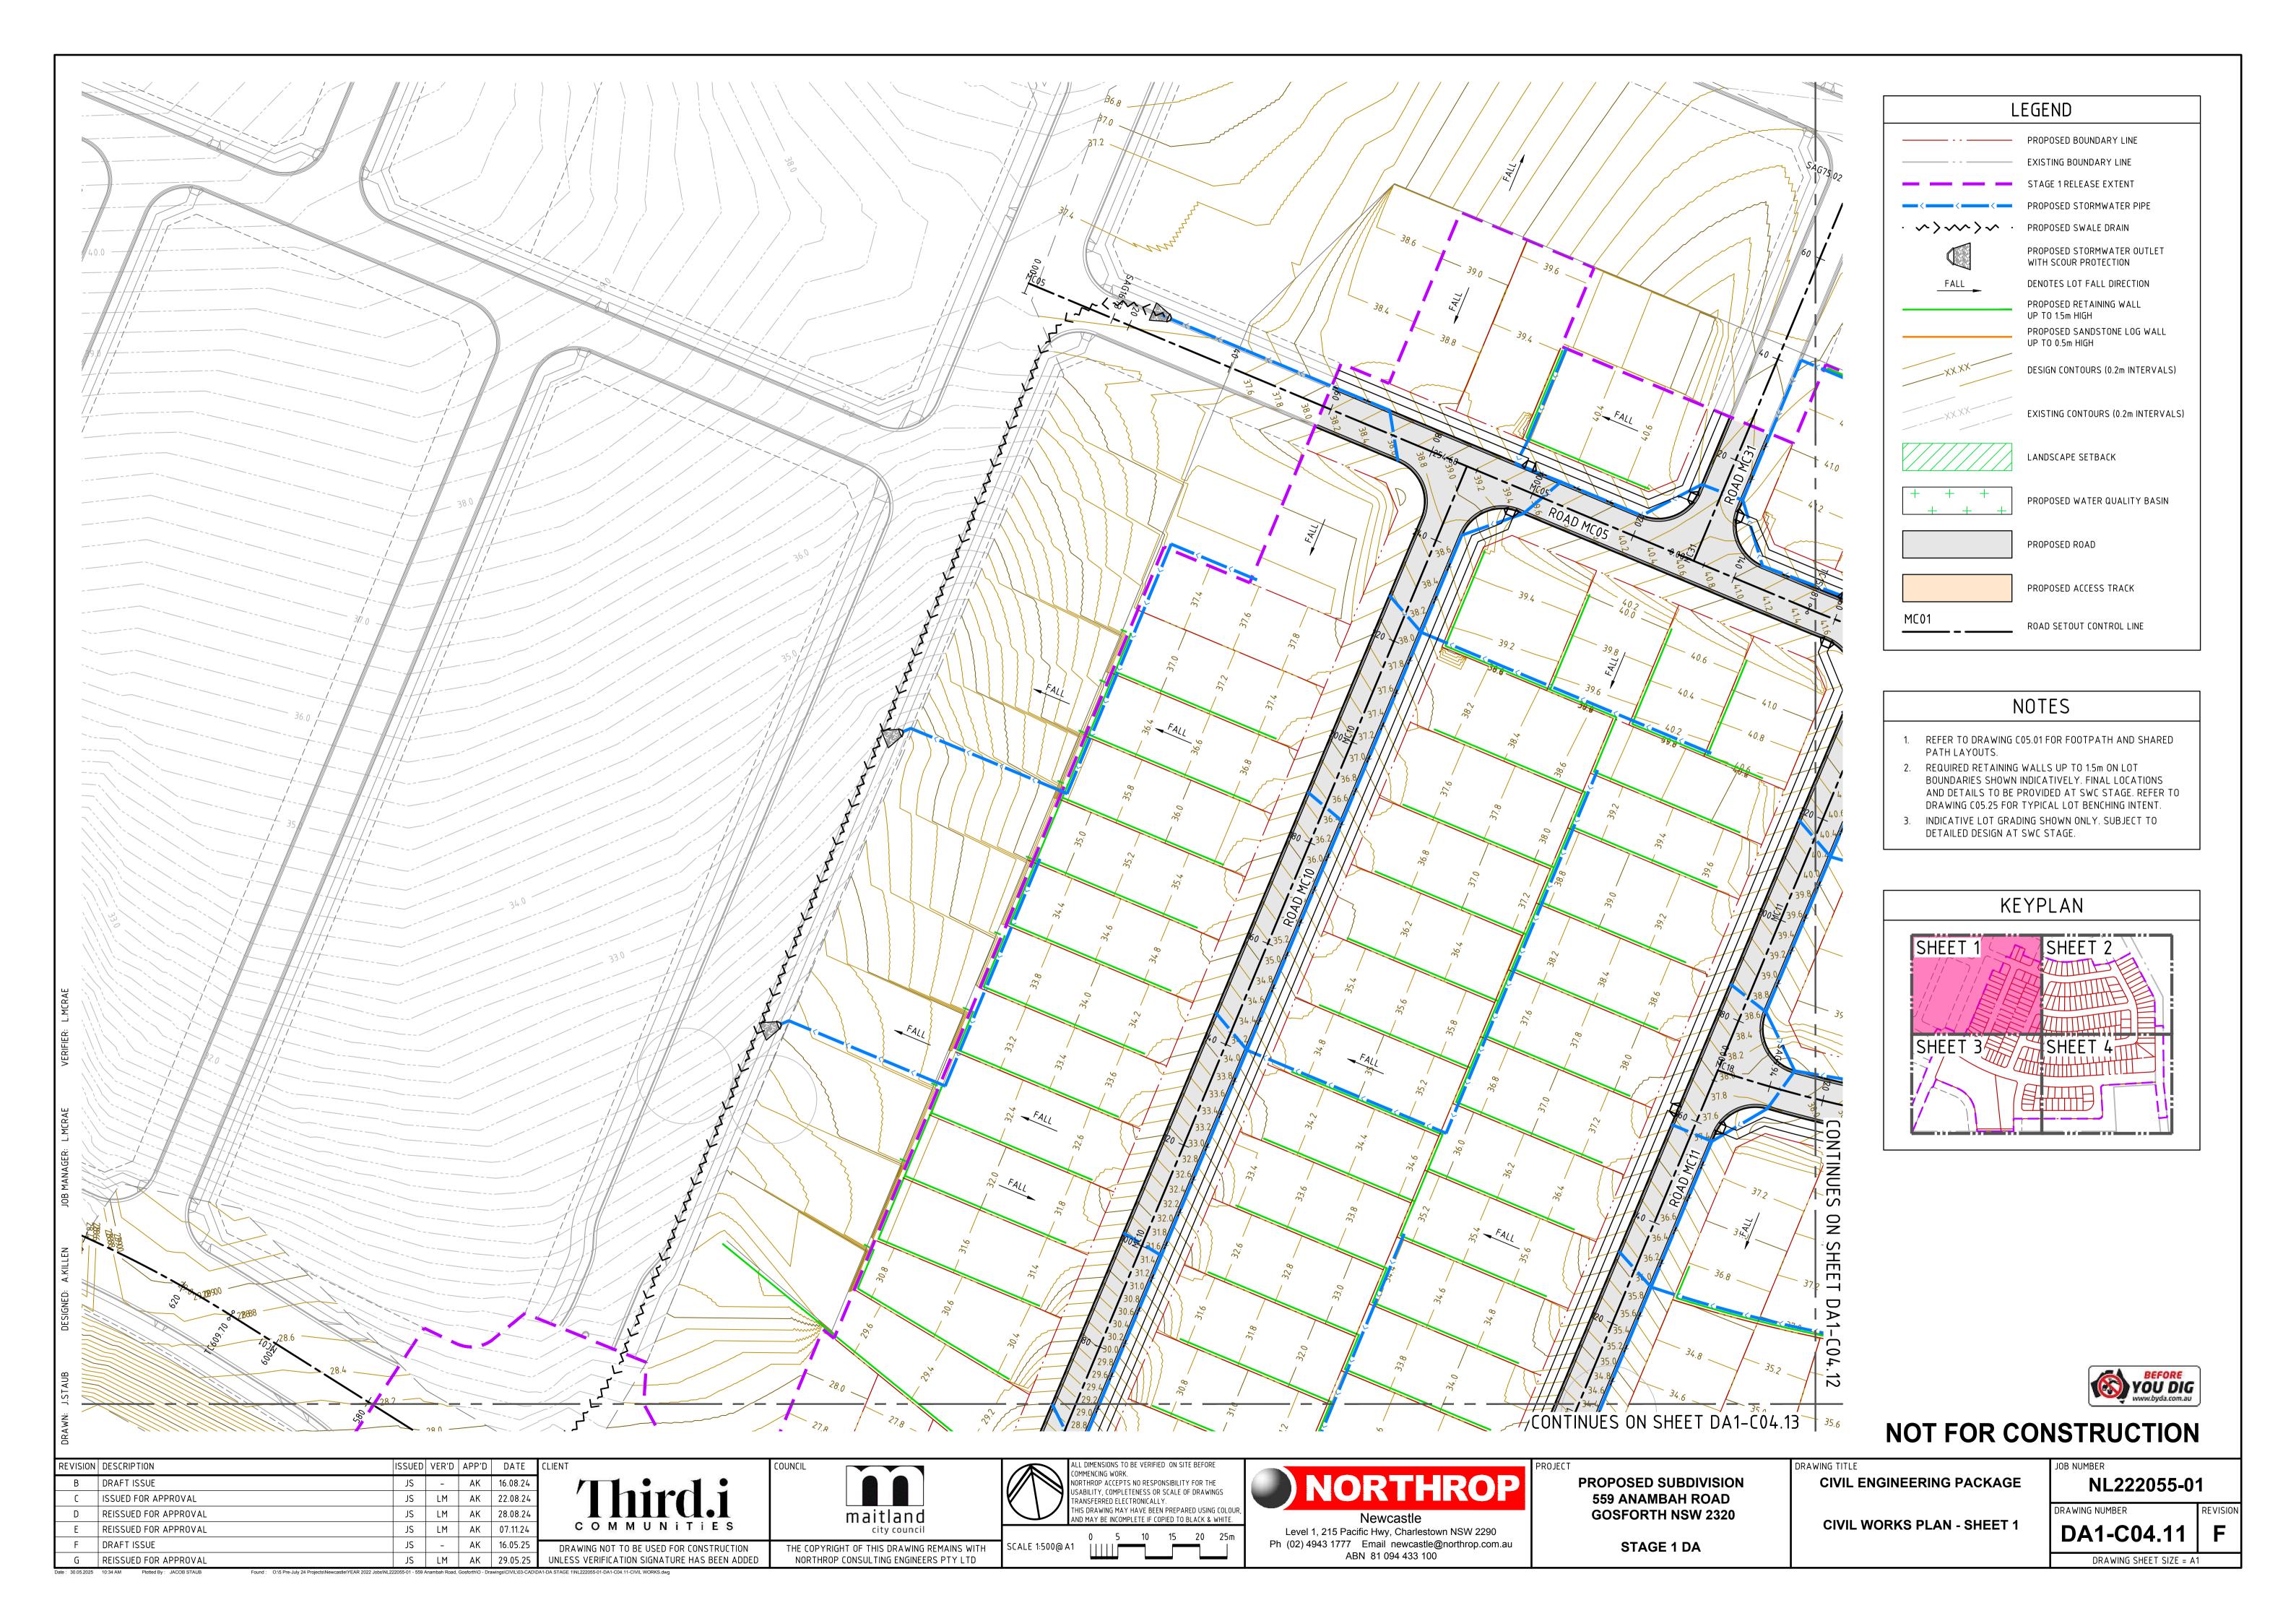
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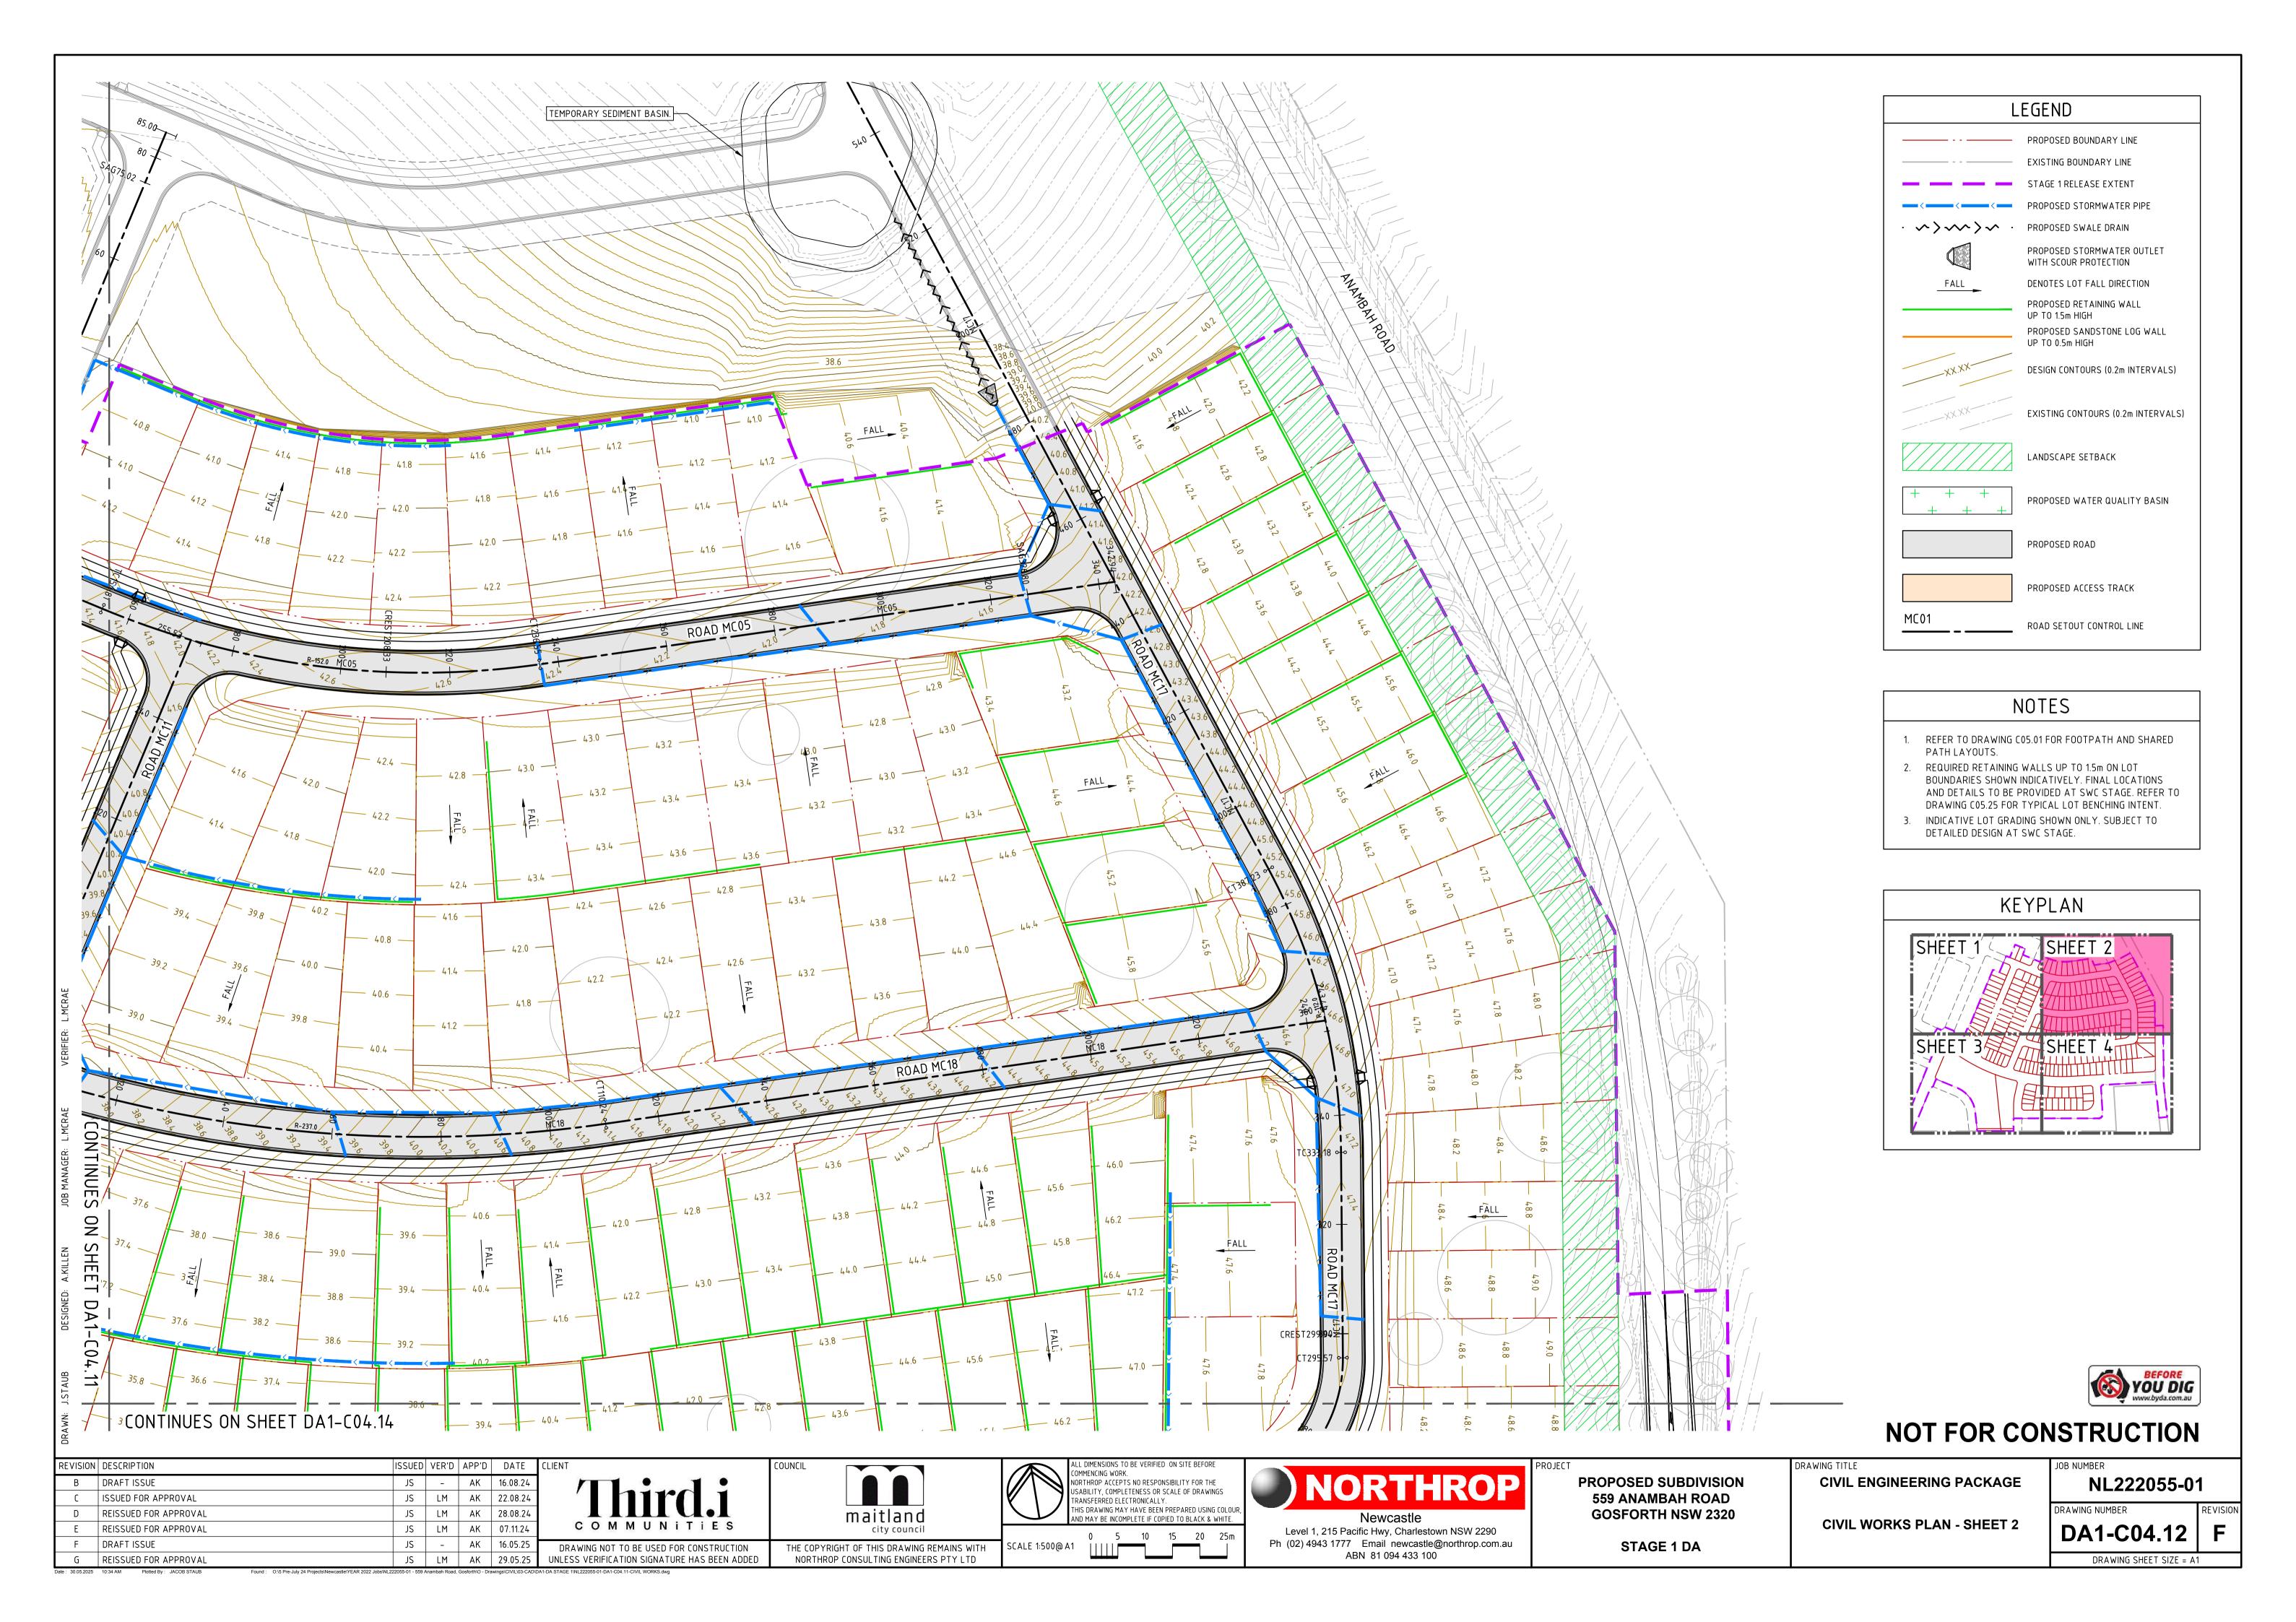
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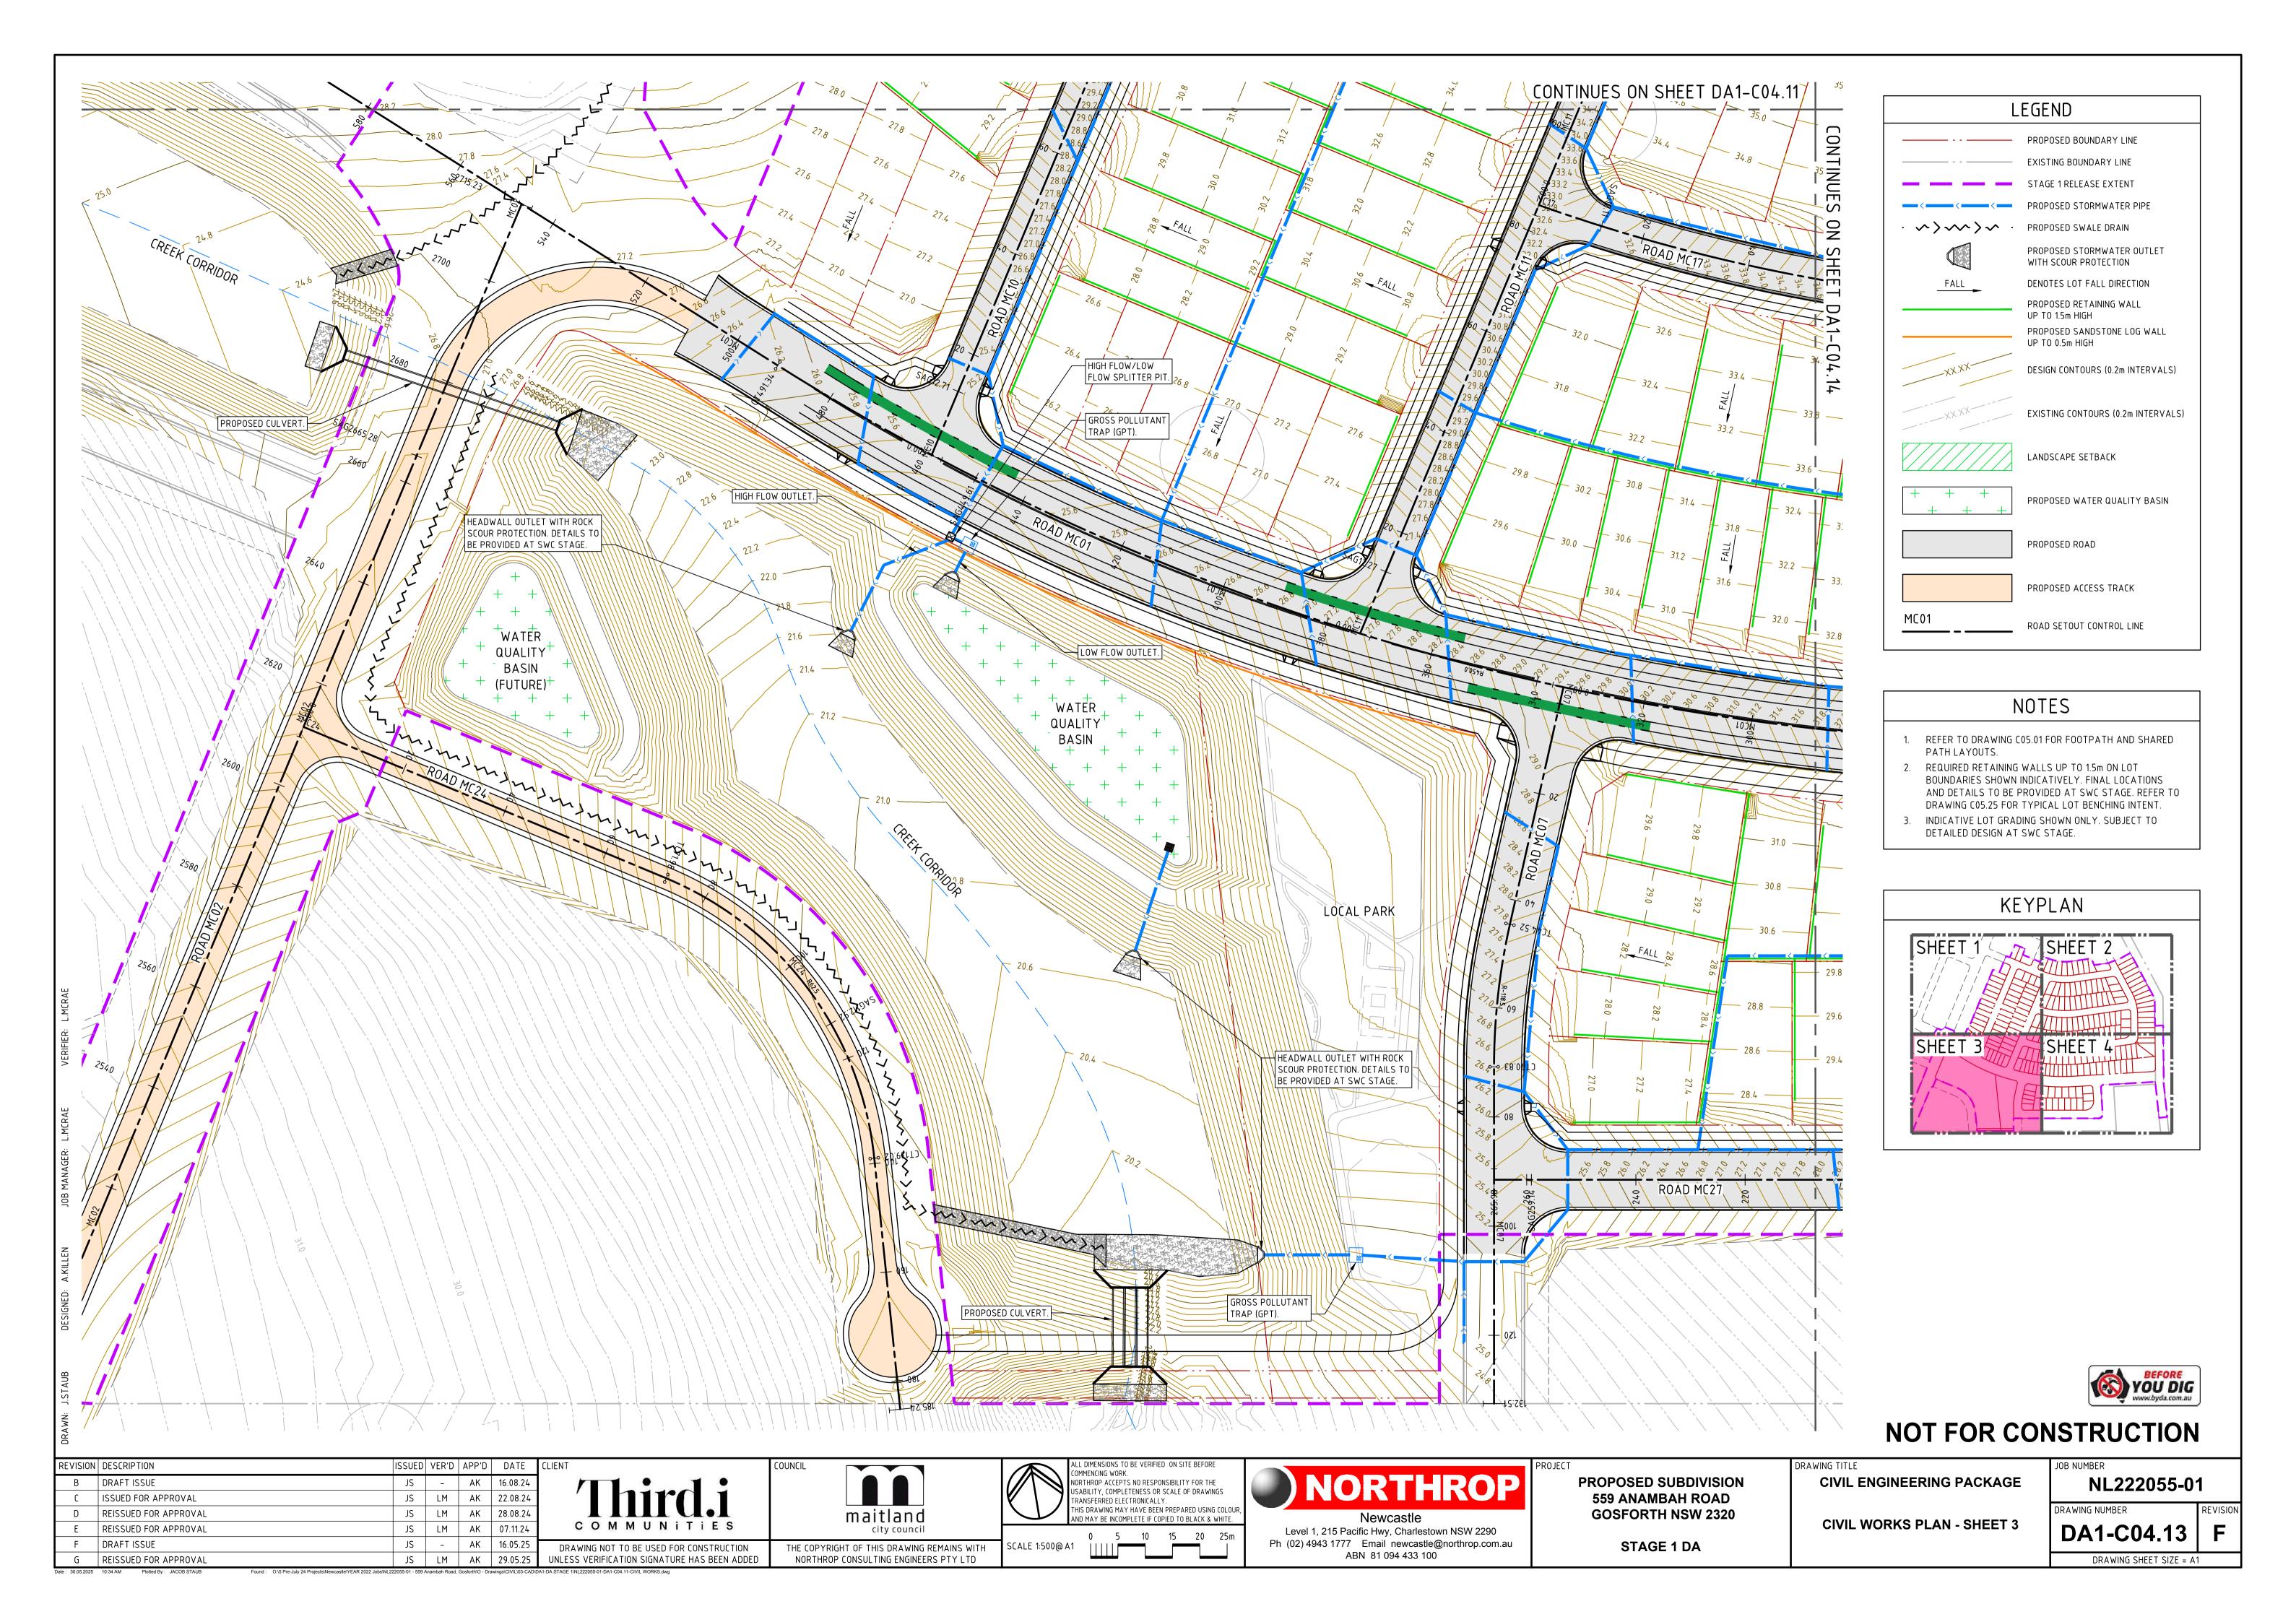
DA1-C04.01 F

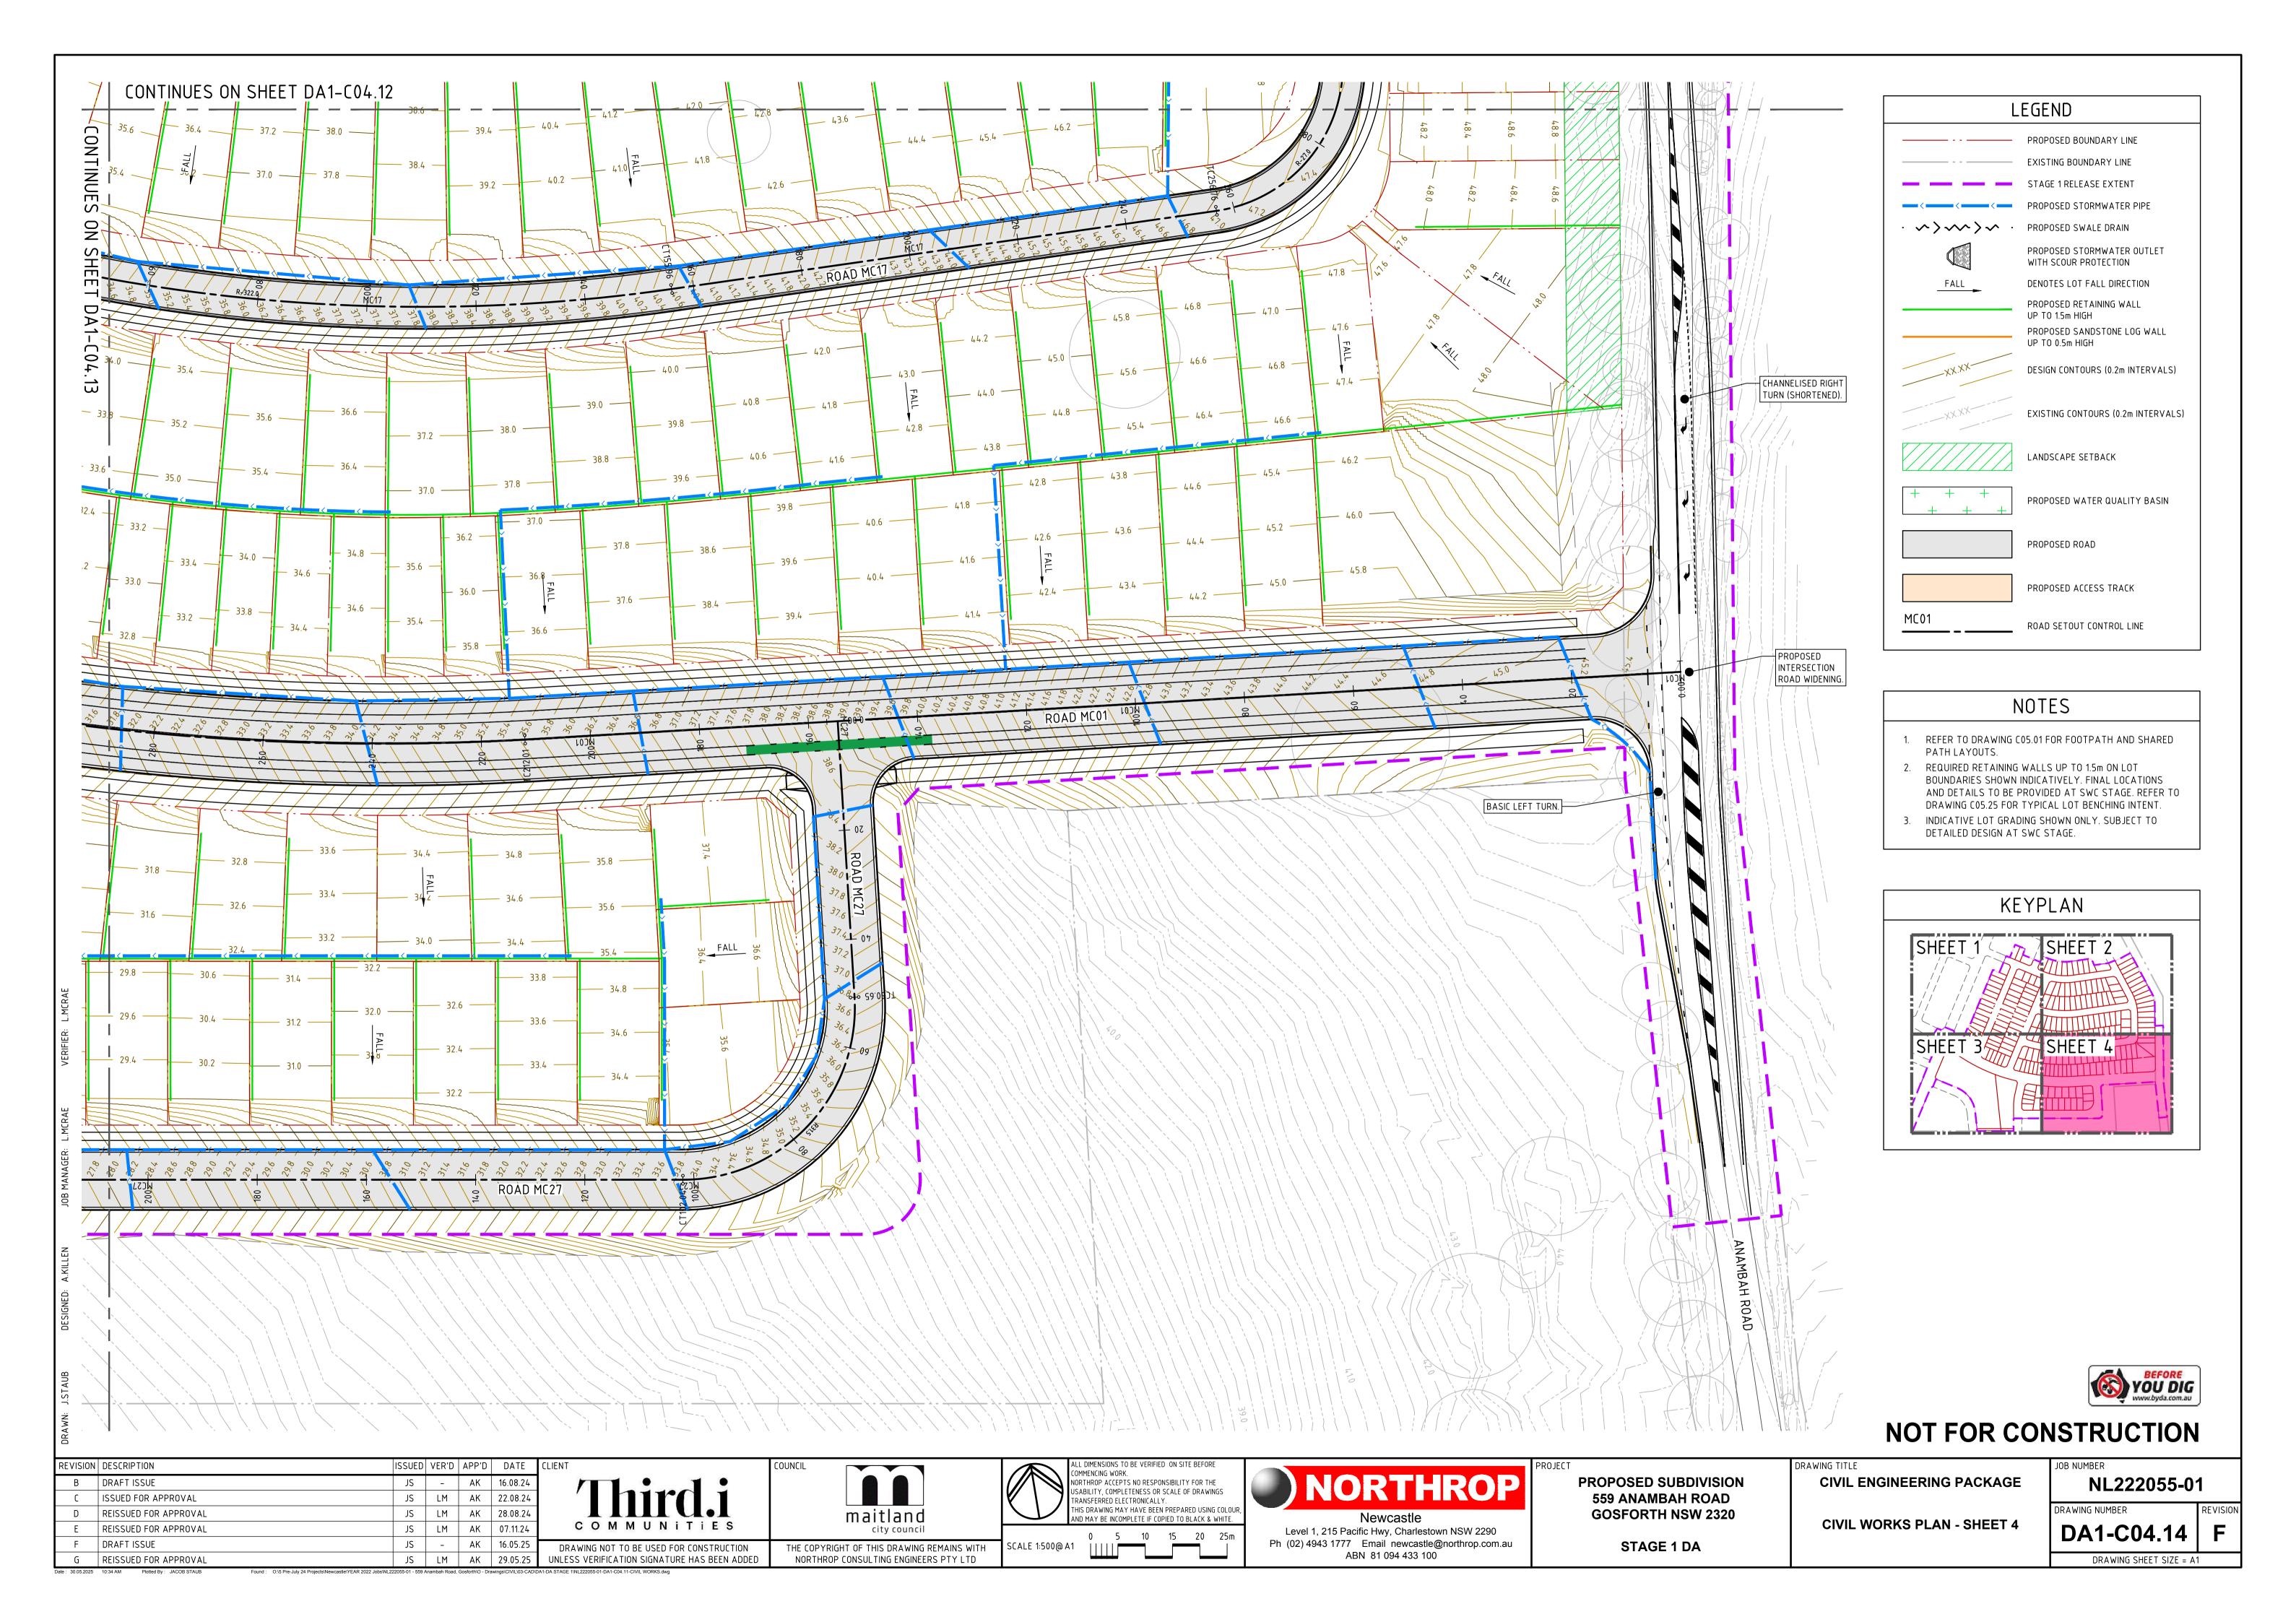
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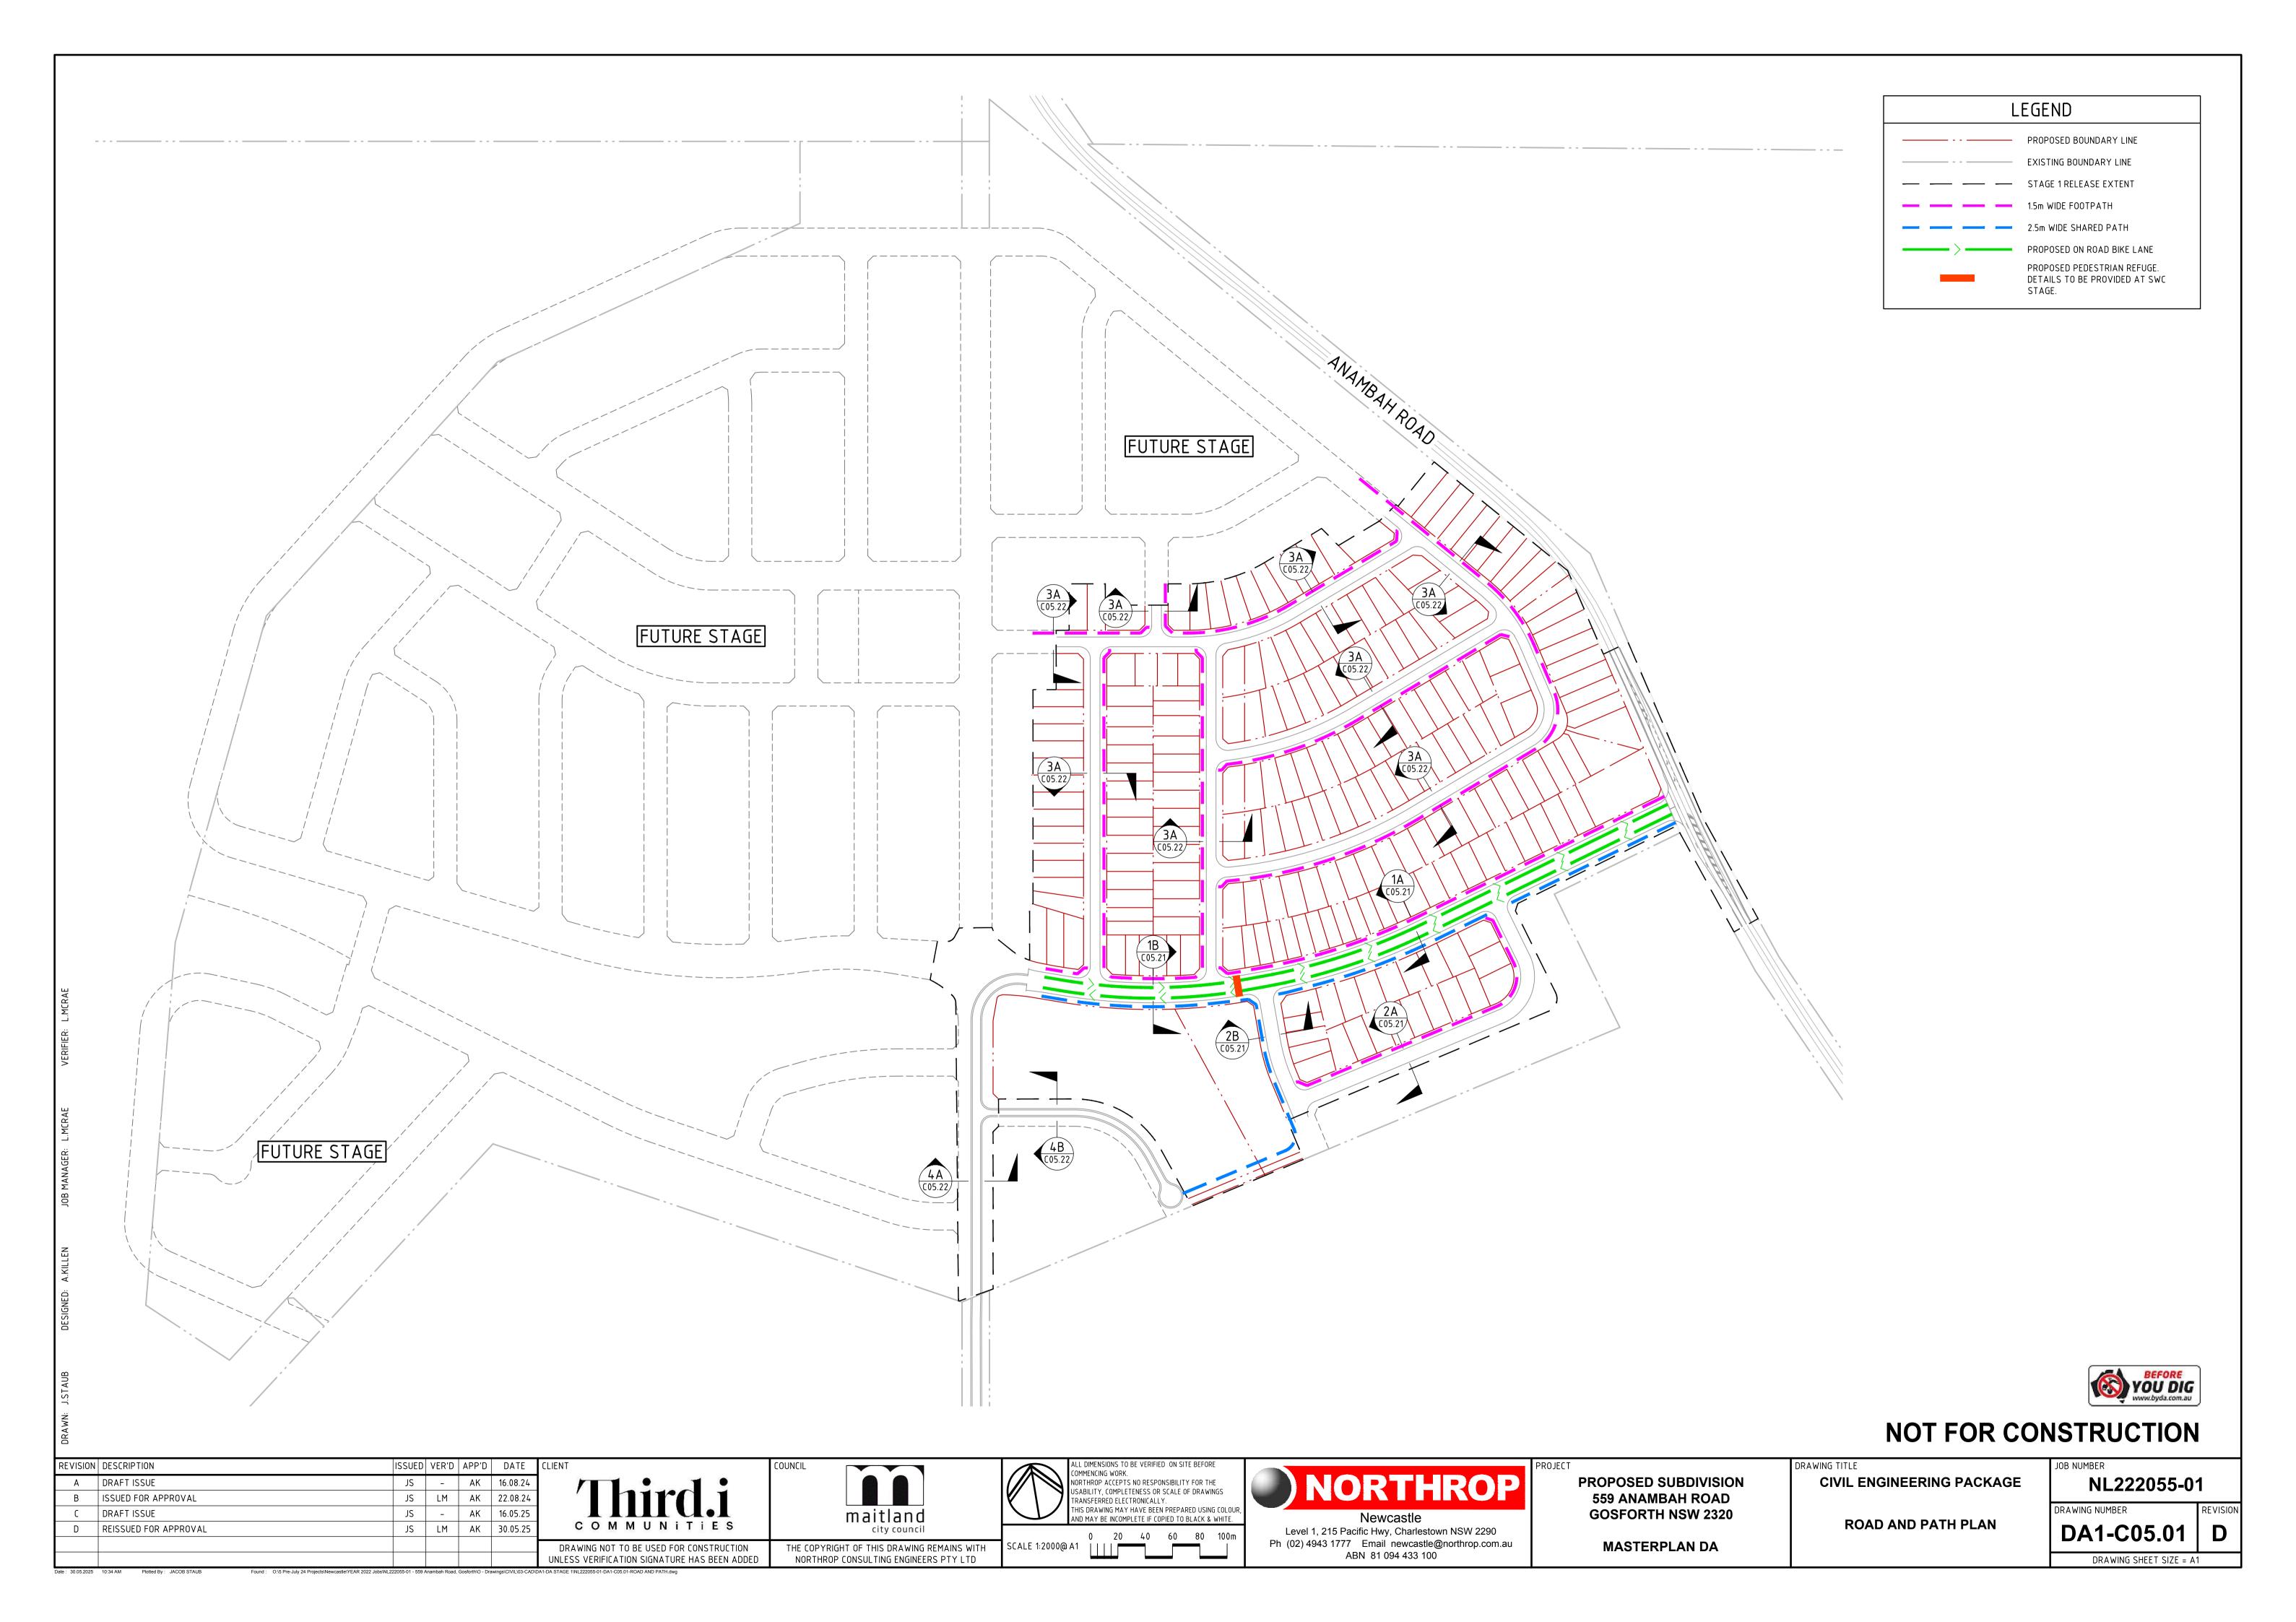


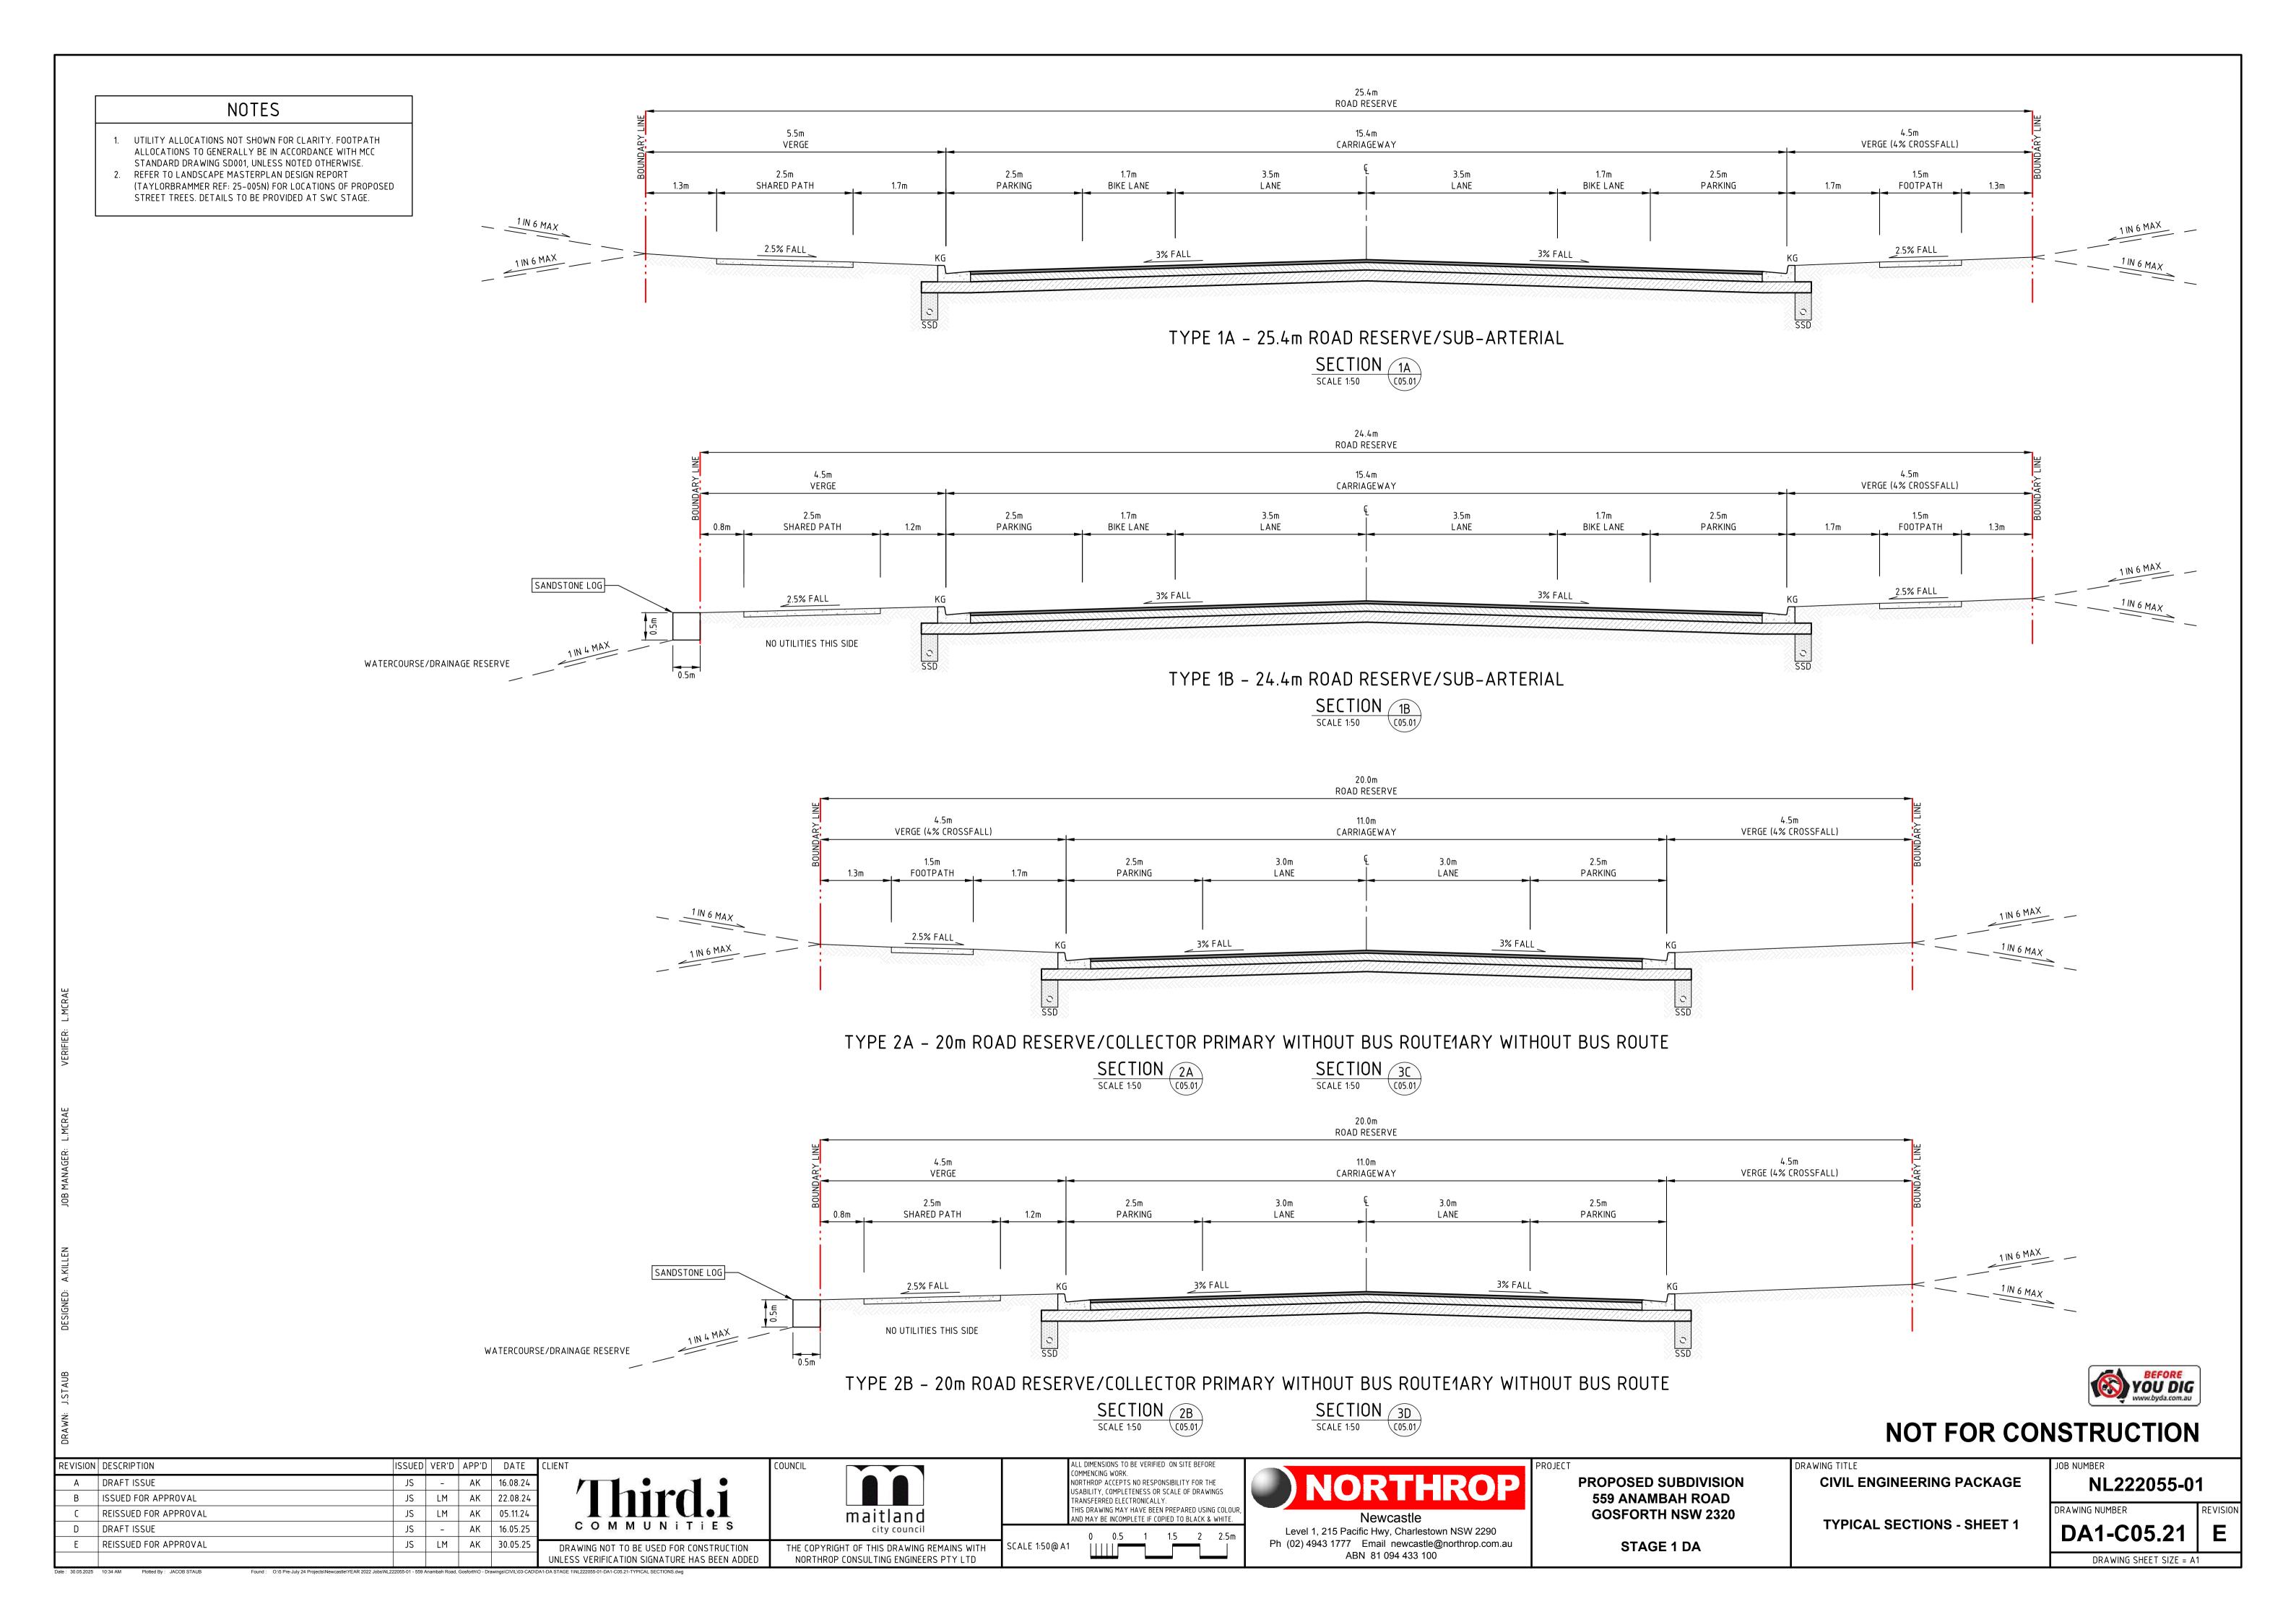


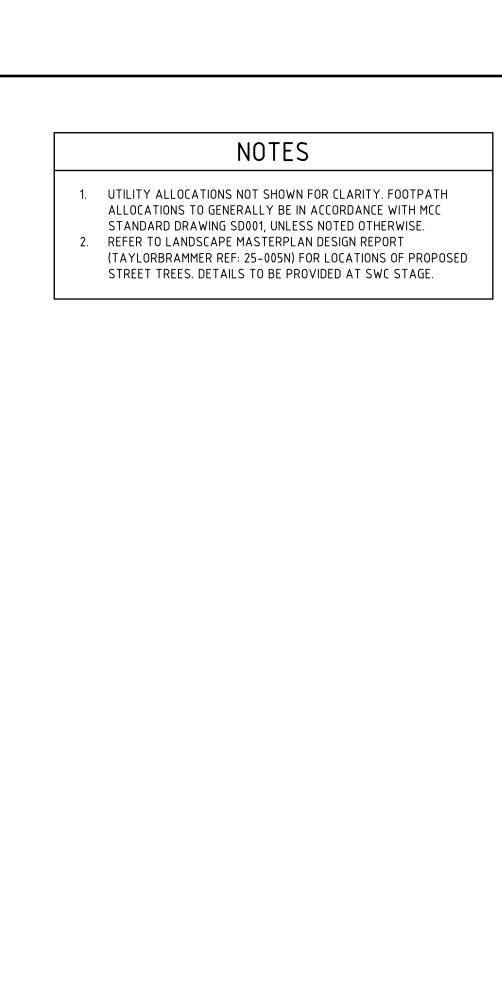


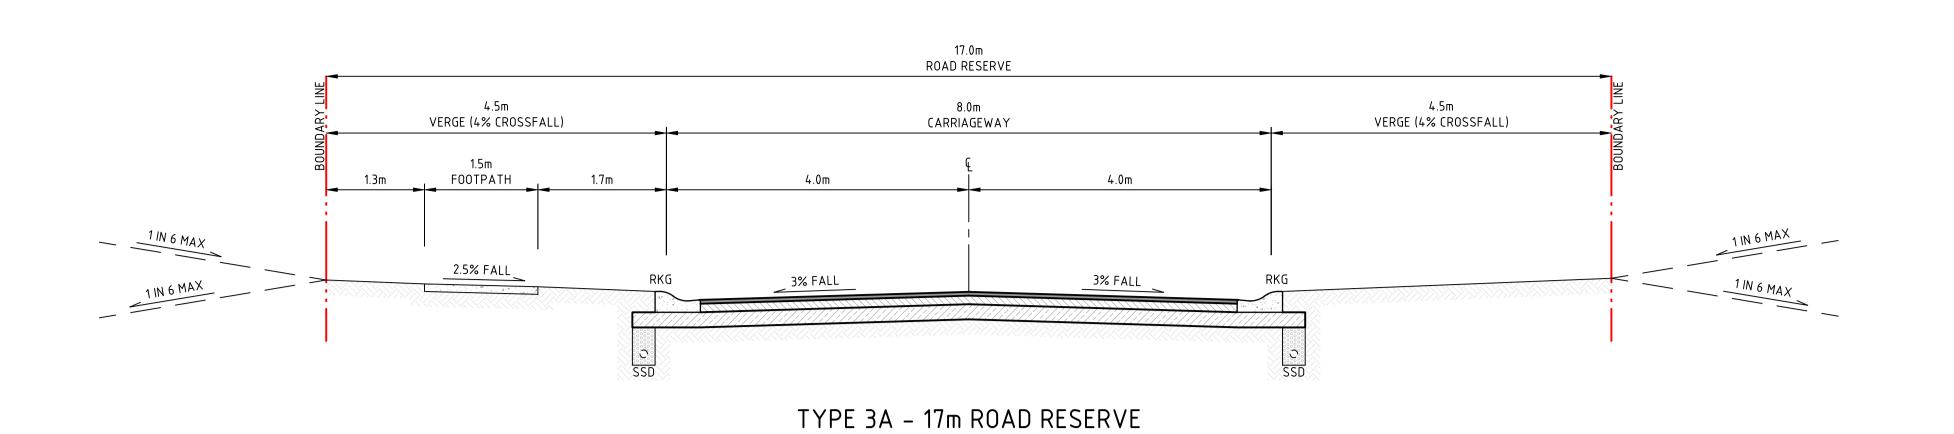














SECTION 3A
SCALE 1:50 C05.01

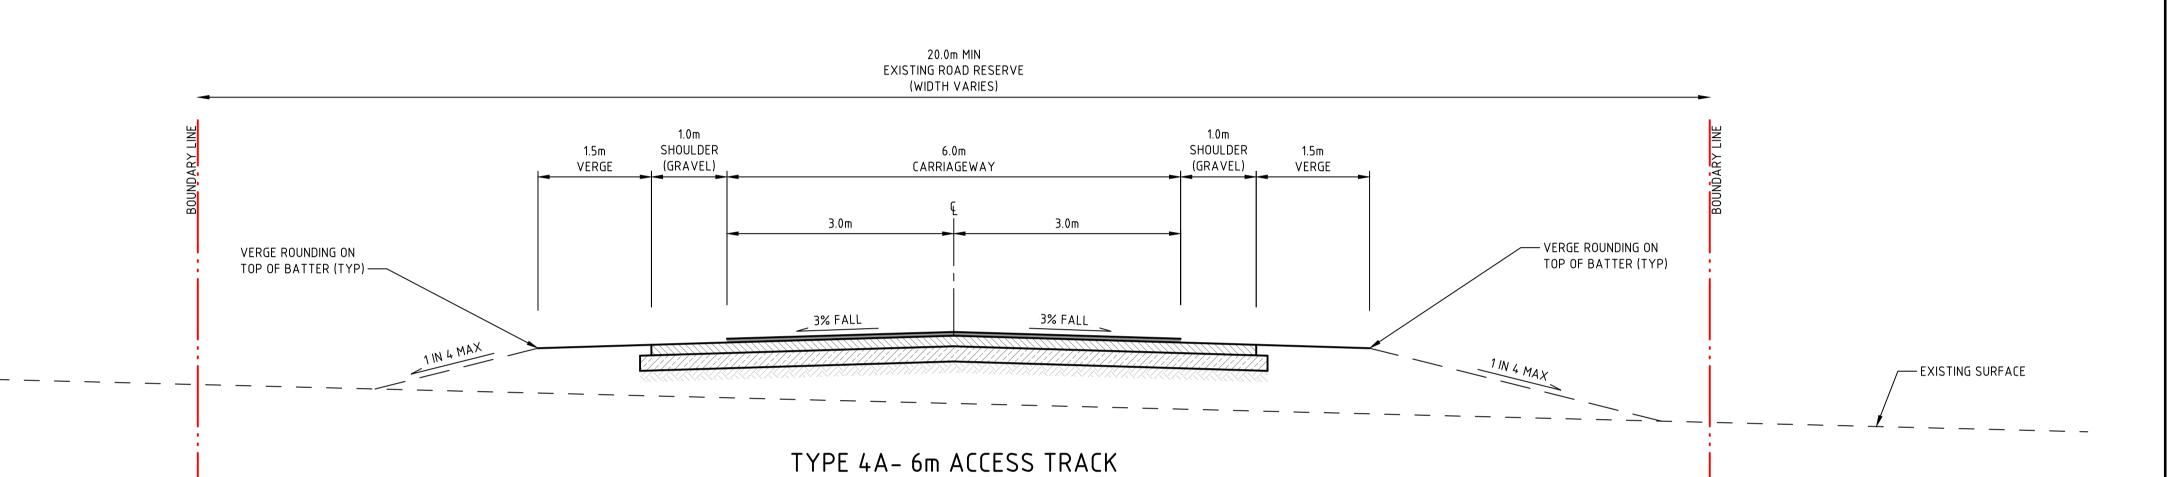

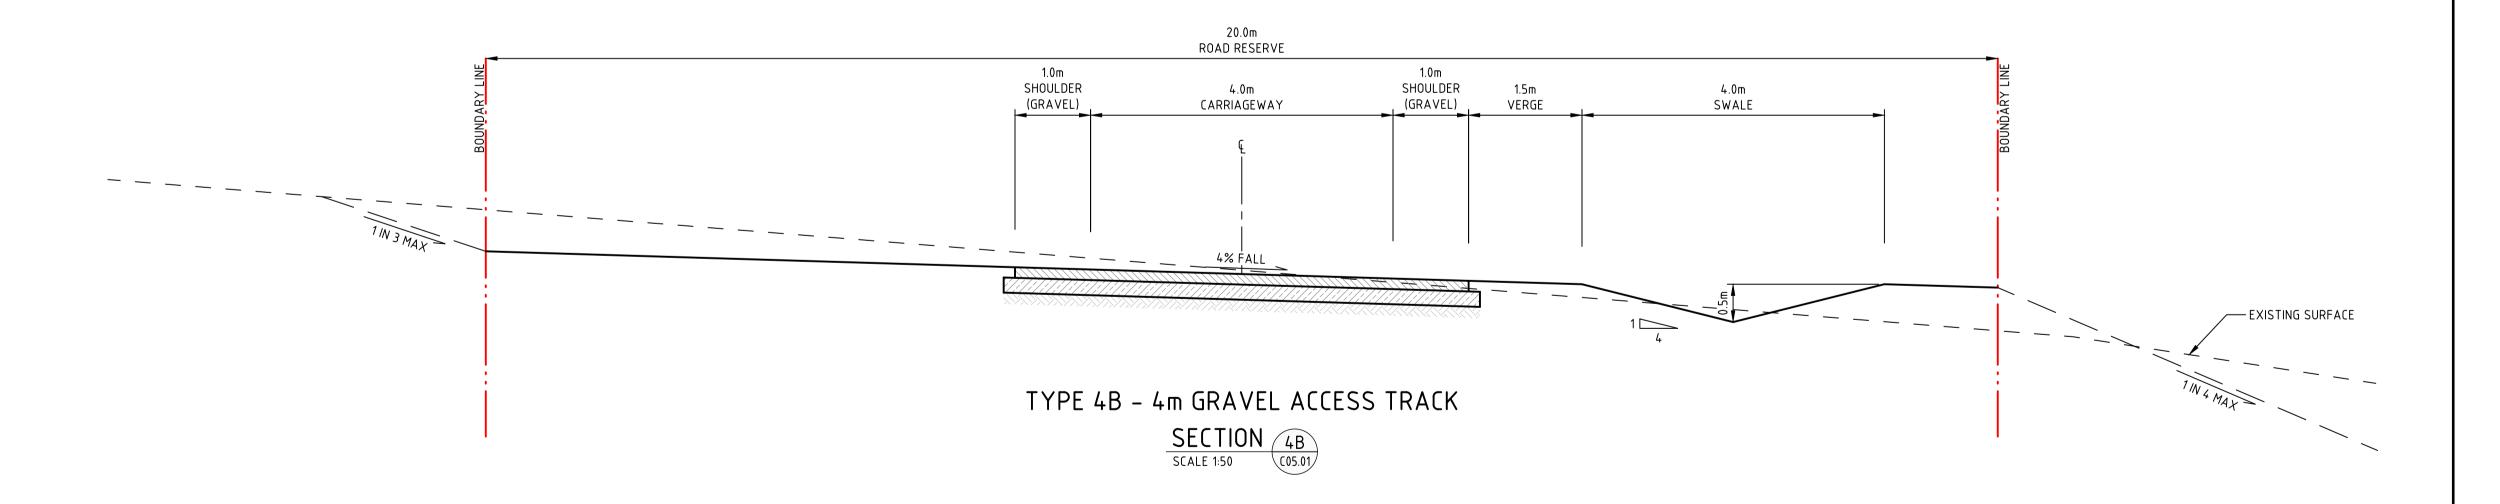

SECTION 4A
SCALE 1:50 C05.01

YOU DIG


NL222055-01

DRAWING SHEET SIZE = A1

DA1-C05.22


NOT FOR CONSTRUCTION


REVISION DESCRIPTION	ISSUED VER'D APP'E	DATE	CLIENT	COUNCIL	ALL DIMENSIONS TO BE VERIFIED ON SITE BEFORE		PROJECT	DRAWING TITLE
A DRAFT ISSUE	JS - AK	16.08.24			COMMENCING WORK. NORTHROP ACCEPTS NO RESPONSIBILITY FOR THE		PROPOSED SUBDIVISION	CIVIL ENGINEERING PACKAGE
B ISSUED FOR APPROVAL	JS LM AK	22.08.24			USABILITY, COMPLETENESS OR SCALE OF DRAWINGS TRANSFERRED ELECTRONICALLY.	NONTINOP	559 ANAMBAH ROAD	
C REISSUED FOR APPROVAL	JS LM AK	05.11.24		maitland	THIS DRAWING MAY HAVE BEEN PREPARED USING COLOUR, AND MAY BE INCOMPLETE IF COPIED TO BLACK & WHITE.	Newcastle	GOSFORTH NSW 2320	TYPICAL OF CTIONS OF CTIONS
D DRAFT ISSUE	JS - AK	16.05.25	COMMUNITIES	city council	0 05 1 15 2 25m	Level 1, 215 Pacific Hwy, Charlestown NSW 2290		TYPICAL SECTIONS - SHEET 2
E REISSUED FOR APPROVAL	JS LM AK	30.05.25	DRAWING NOT TO BE USED FOR CONSTRUCTION	THE COPYRIGHT OF THIS DRAWING REMAINS WITH	SCALE 1:50@ A1	Ph (02) 4943 1777 Email newcastle@northrop.com.au	STAGE 1 DA	
			UNLESS VERIFICATION SIGNATURE HAS BEEN ADDED	NORTHROP CONSULTING ENGINEERS PTY LTD		ABN 81 094 433 100		

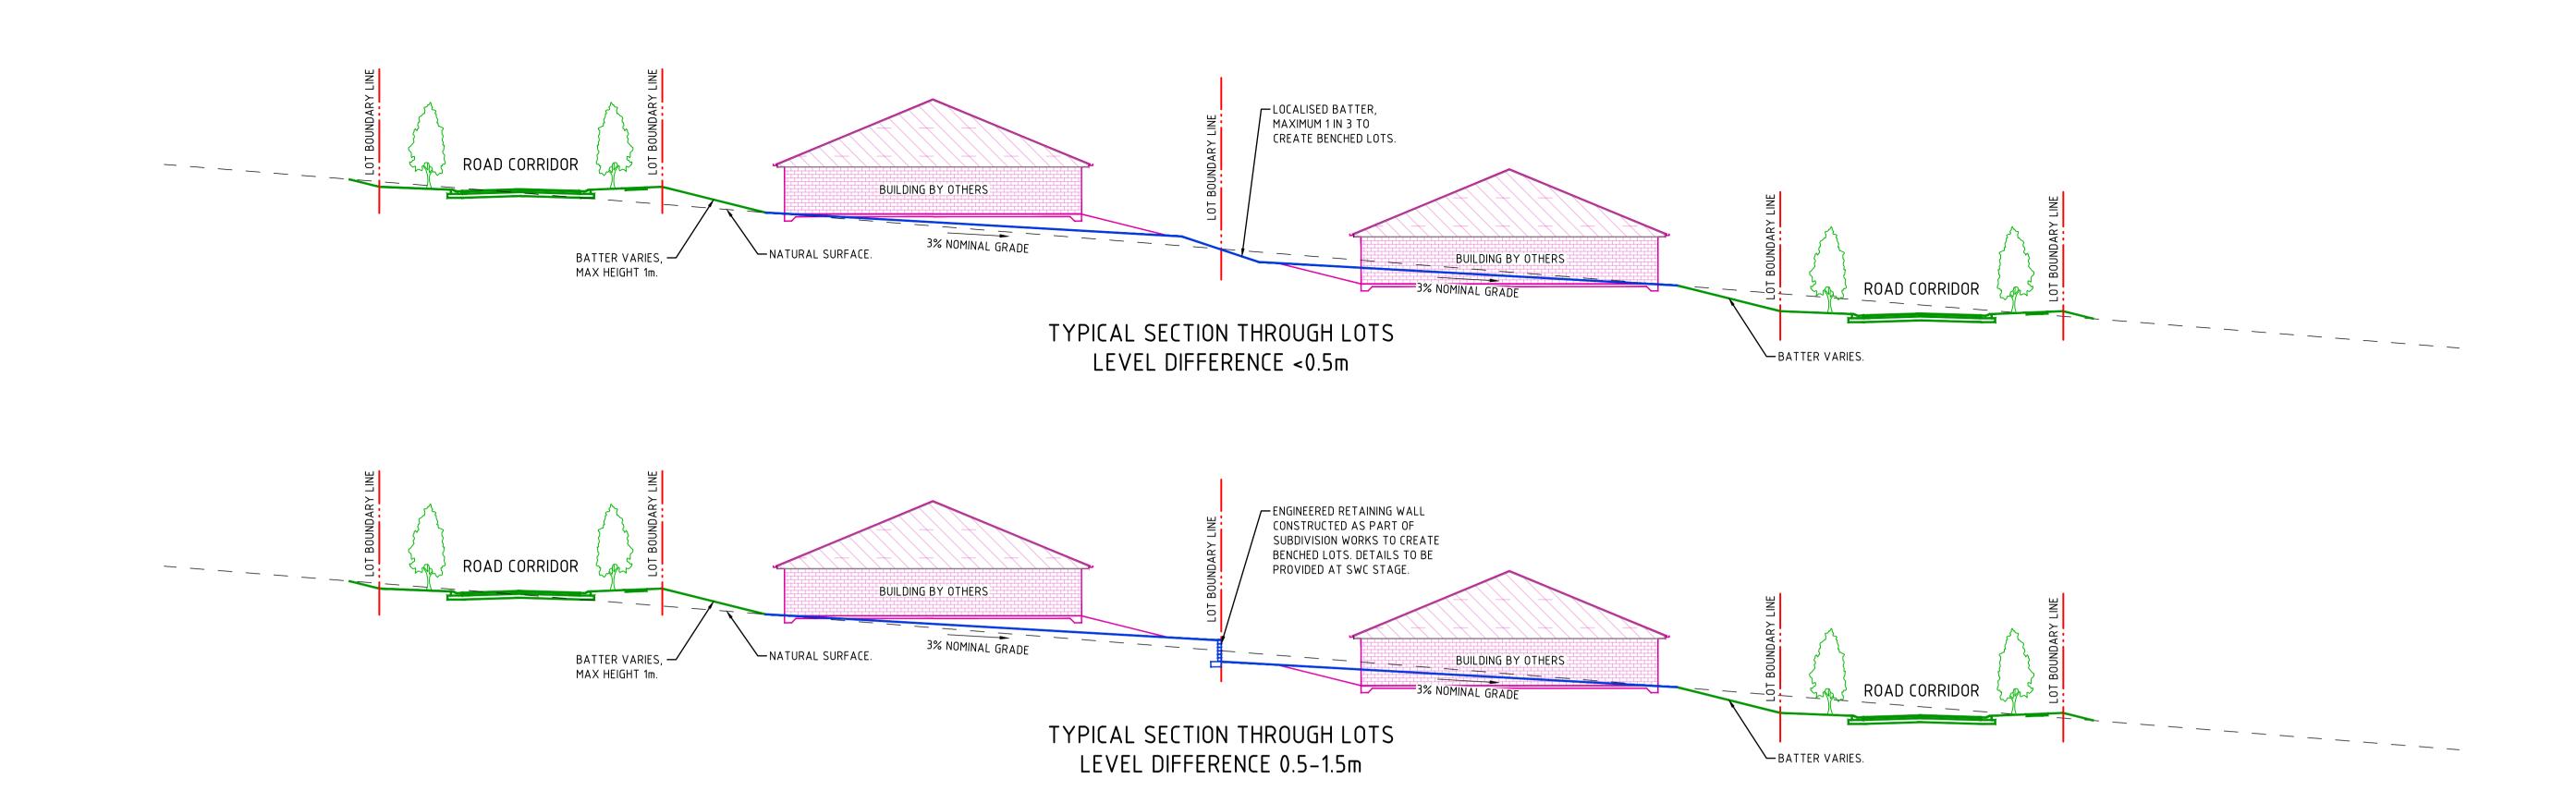



REVISION DESCRIPTION ISSUED VER'D APP'D DATE OMMENCING WORK. NL222055-01 PROPOSED SUBDIVISION CIVIL ENGINEERING PACKAGE NORTHROP ACCEPTS NO RESPONSIBILITY FOR THE USABILITY, COMPLETENESS OR SCALE OF DRAWINGS JS – AK 16.08.24 A DRAFT ISSUE 559 ANAMBAH ROAD JS LM AK 22.08.24 B ISSUED FOR APPROVAL TRANSFERRED ELECTRONICALLY.
THIS DRAWING MAY HAVE BEEN PREPARED USING COLOUR,
AND MAY BE INCOMPLETE IF COPIED TO BLACK & WHITE. DRAWING NUMBER **GOSFORTH NSW 2320** JS – AK 16.05.25 C DRAFT ISSUE maitland city council Newcastle TYPICAL SECTIONS THROUGH LOTS D REISSUED FOR APPROVAL JS LM AK 30.05.25 DA1-C05.25 Level 1, 215 Pacific Hwy, Charlestown NSW 2290 Ph (02) 4943 1777 Email newcastle@northrop.com.au NOT TO SCALE STAGE 1 DA THE COPYRIGHT OF THIS DRAWING REMAINS WITH DRAWING NOT TO BE USED FOR CONSTRUCTION ABN 81 094 433 100 NORTHROP CONSULTING ENGINEERS PTY LTD UNLESS VERIFICATION SIGNATURE HAS BEEN ADDED DRAWING SHEET SIZE = A1

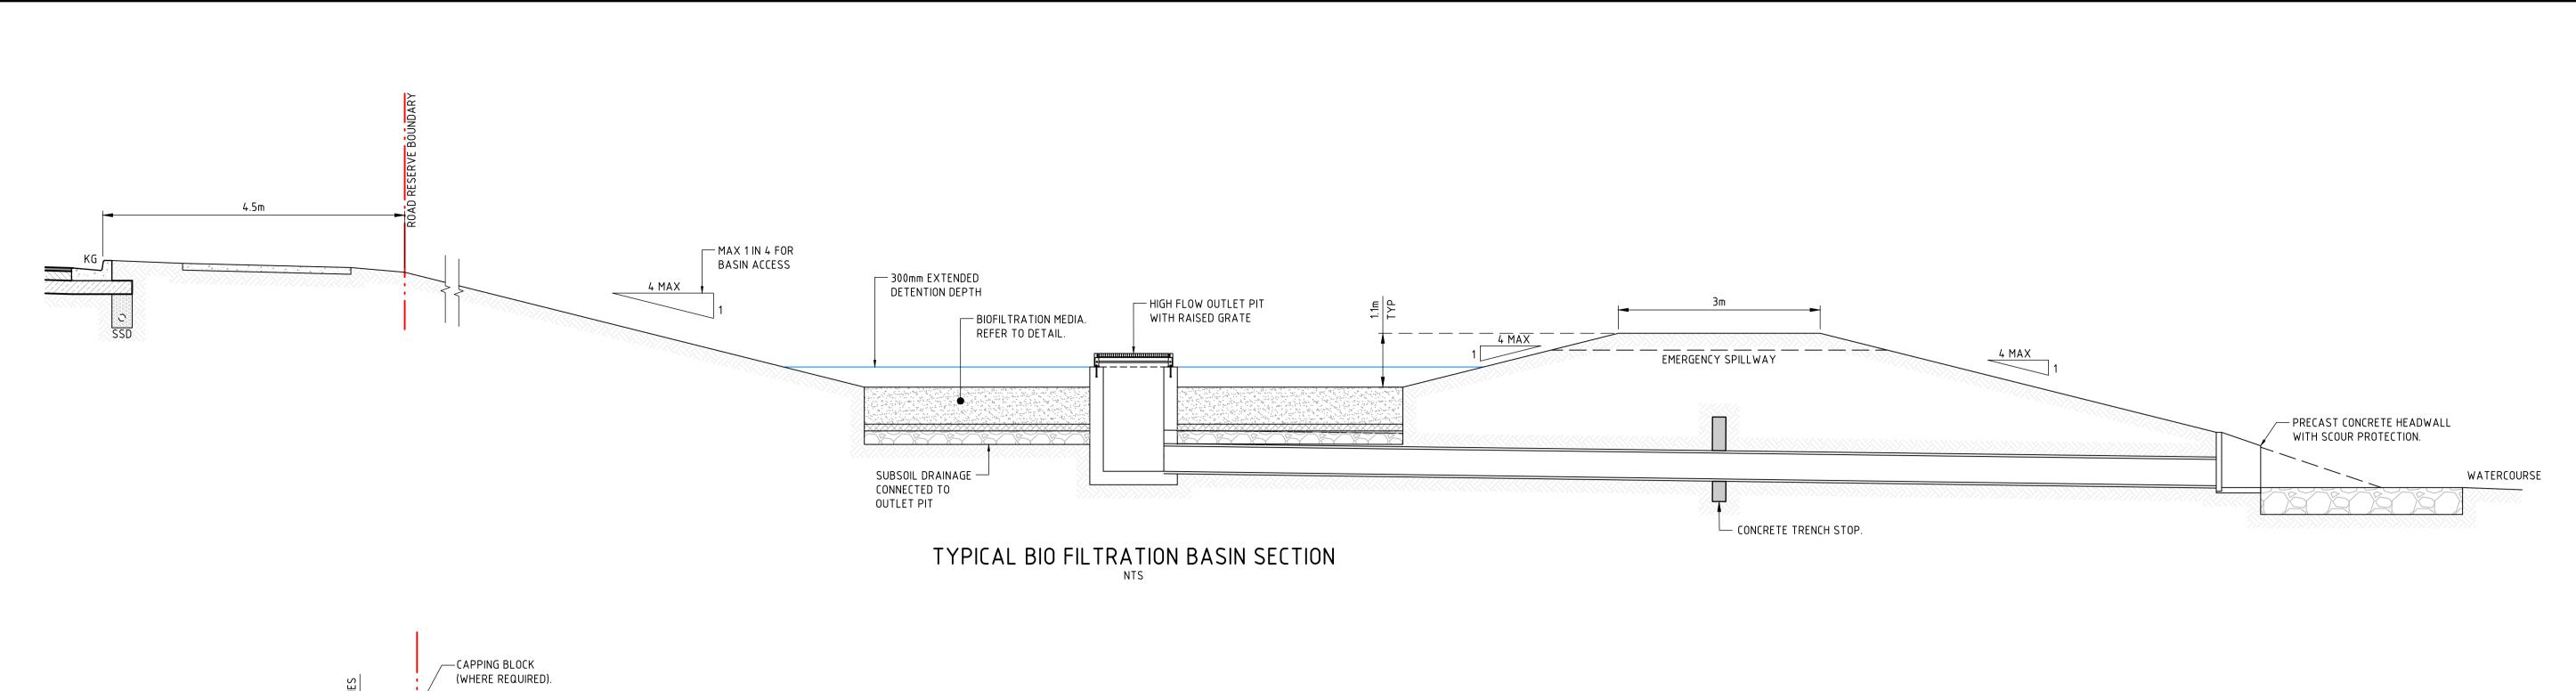

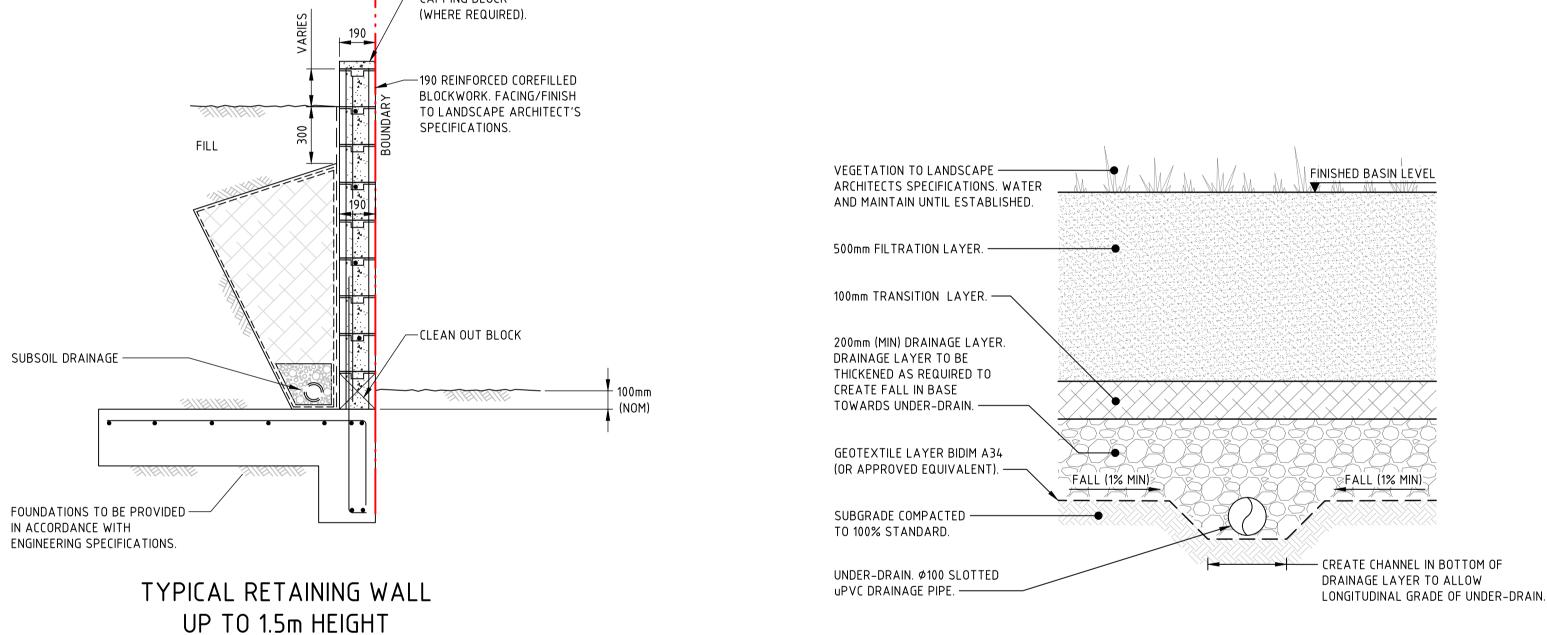


BLOCKWORK RETAINING WALL OPTION SHOWN. FINAL WALL TYPE AND STRUCTURAL DETAILING TO BE CONFIRMED AT SWC STAGE.

BIOFILTRATION MEDIA DETAIL



NOT FOR CONSTRUCTION

REVISION DESCRIPTION ISSUED VER'D APP'D DATE OMMENCING WORK. PROPOSED SUBDIVISION CIVIL ENGINEERING PACKAGE NL222055-01 NORTHROP ACCEPTS NO RESPONSIBILITY FOR THE USABILITY, COMPLETENESS OR SCALE OF DRAWINGS A DRAFT ISSUE - AK 16.08.24 **559 ANAMBAH ROAD** B ISSUED FOR APPROVAL JS LM AK 22.08.24 TRANSFERRED ELECTRONICALLY. THIS DRAWING MAY HAVE BEEN PREPARED USING COLOUR
AND MAY BE INCOMPLETE IF COPIED TO BLACK & WHITE. DRAWING NUMBER **GOSFORTH NSW 2320** C REISSUED FOR APPROVAL JS | LM | AK | 05.11.24 maitland city council Newcastle TYPICAL CIVIL DETAILS D DRAFT ISSUE AK 16.05.25 DA1-C05.26 Level 1, 215 Pacific Hwy, Charlestown NSW 2290 E REISSUED FOR APPROVAL NOT TO SCALE Ph (02) 4943 1777 Email newcastle@northrop.com.au JS | LM | AK | 30.05.25 STAGE 1 DA DRAWING NOT TO BE USED FOR CONSTRUCTION THE COPYRIGHT OF THIS DRAWING REMAINS WITH ABN 81 094 433 100 NORTHROP CONSULTING ENGINEERS PTY LTD UNLESS VERIFICATION SIGNATURE HAS BEEN ADDED DRAWING SHEET SIZE = A1

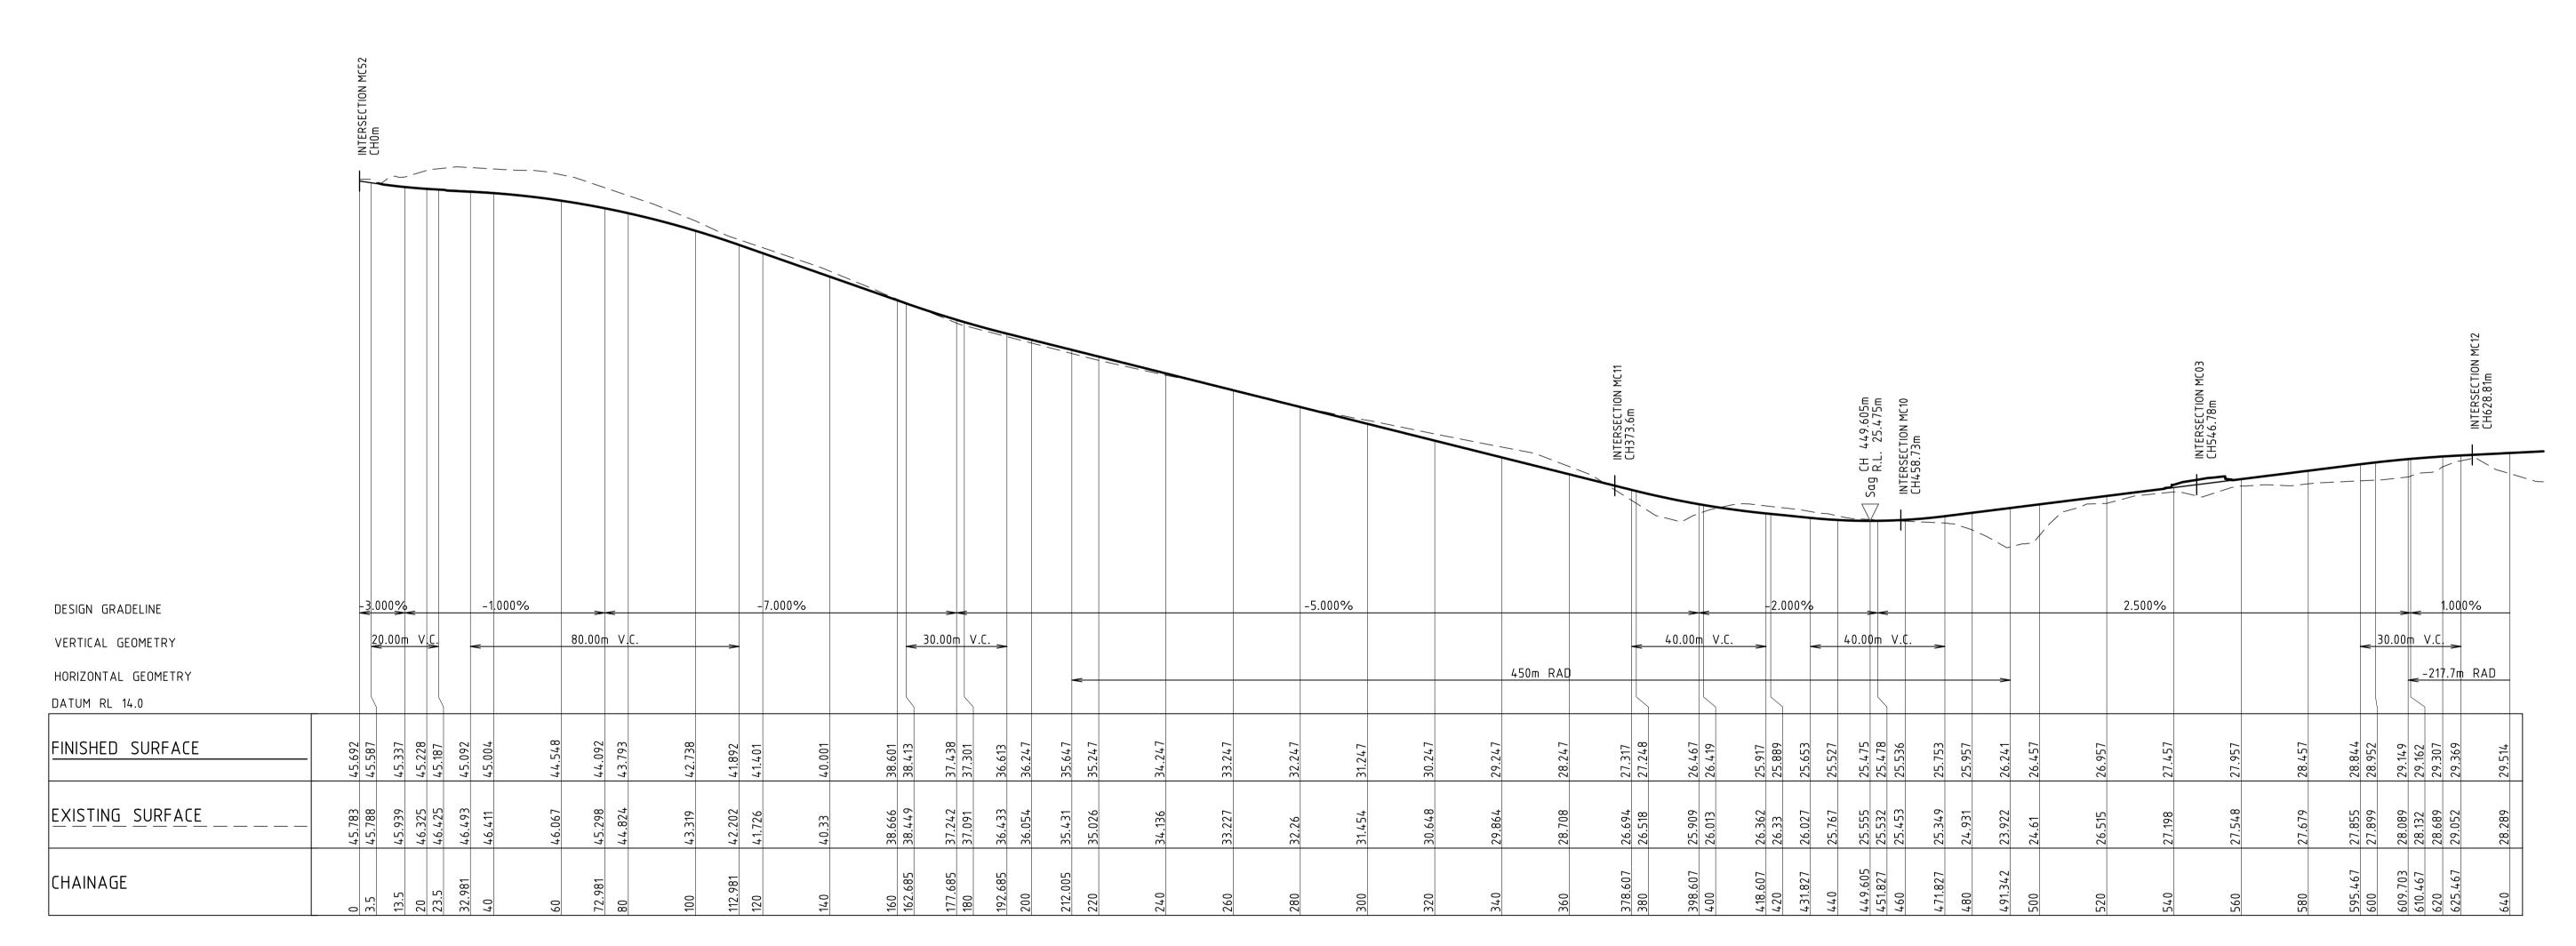


LONGITUDINAL SECTION ALONG MC01 HORIZONTAL SCALE 1:1000@A1 VERTICAL SCALE 1:200@A1



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REVISIO	N DESCRIPTION	ISSUED VER'D APP'D DATE CLIENT	COUNCIL	ALL DIMENSIONS TO BE VERIFIED ON SITE BEFORE COMMENCING WORK.		PROJECT	DRAWING TITLE	JOB NUMBER
Α	DRAFT ISSUE	JS - AK 07.08.24		NORTHRON ACCEPTS NO RESPONSIBILITY FOR THE		PROPOSED SUBDIVISION	CIVIL ENGINEERING PACKAGE	NL222055-01
В	DRAFT ISSUE	JS - AK 16.08.24		TRANSFERRED ELECTRONICALLY.	NONTIMOR	559 ANAMBAH ROAD		
С	ISSUED FOR APPROVAL	JS LM AK 22.08.24	maitland	THIS DRAWING MAY HAVE BEEN PREPARED USING COLOUR, AND MAY BE INCOMPLETE IF COPIED TO BLACK & WHITE.	Newcastle	GOSFORTH NSW 2320		DRAWING NUMBER REVISION
D	DRAFT ISSUE	JS - AK 16.05.25 COMMUNITIES	city council	SCALE 4500@ A4 0 5 10 15 20 25m	Level 1, 215 Pacific Hwy, Charlestown NSW 2290		ROAD LONGITUDINAL SECTIONS -	DA1-C05.31 E
Е	REISSUED FOR APPROVAL	JS LM AK 30.05.25 DRAWING NOT TO BE USED FOR CONSTRUCTION	THE COPYRIGHT OF THIS DRAWING REMAINS WITH	SCALE 1:500@ A1	Ph (02) 4943 1777 Email newcastle@northrop.com.au	STAGE 1 DA	SHEET 1	DA1 000.01 L
		UNLESS VERIFICATION SIGNATURE HAS BEEN ADD	ED NORTHROP CONSULTING ENGINEERS PTY LTD	SCALE 1:100 @ A1 0 1 2 3 4 5m	ABN 81 094 433 100			DRAWING SHEET SIZE = A1





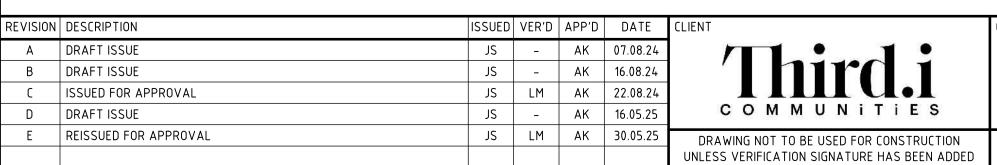

ALL DIMENSIONS TO BE VERIFIED ON SITE BEFORE COMMENCING WORK.



PROPOSED SUBDIVISION 559 ANAMBAH ROAD **GOSFORTH NSW 2320**

STAGE 1 DA

CIVIL ENGINEERING PACKAGE

ROAD LONGITUDINAL SECTIONS -SHEET 2

NL222055-01 DRAWING NUMBER DA1-C05.32

DRAWING SHEET SIZE = A1

NOT FOR CONSTRUCTION

			Cresi R.L.								Sag CH 2665.28m			INTERSECTION MC03 CH2715.23m
DESIGN GRADELINE VERTICAL GEOMETRY HORIZONTAL GEOMETRY	6. <u>371%</u>		140.00m	-3.359 V.C.	%		40.00m V.C	-5.812% 	40.00m V.	-1.286% C. 30	.00m V.C.		.833%	
FINISHED SURFACE	32.216	32.446	32.398	32.071	31.649	30.837	30.042	29.002 28.947 28.869	27.982	27.468 27.45 27.376	27.269 27.263 27.259	27.308	27.499	27.626
EXISTING SURFACE	32.775	32.486	32.174	31.942	31.618	30.963	30.176	28.953 28.89 28.8	27.524		24.166 24.077 24.04	24.25	26.087	26.959
CHAINAGE	2460 2464.878	2480.544		2520	2534.878 2540	2559.055	2579.055 2580	2599.055 2600 2601.343	2620 2621.343		2660 2662.073 2665.28	2677.073 2680	2700	2715.231






Α	DRAFT ISSUE	JS	_	AK	07.08.24				NORTHROP ACCEPTS			
В	DRAFT ISSUE	JS	_	AK	16.08.24	'I MITA 1			USABILITY, COMPLE TRANSFERRED ELEC		LE UF DRAWIN	NUS
С	ISSUED FOR APPROVAL	JS	LM	AK	22.08.24		maitland		THIS DRAWING MAY AND MAY BE INCOME			
D	DRAFT ISSUE	JS	-	AK	16.05.25	COMMUNITIES	city council		0 5	10 15	5 20	25m
Е	REISSUED FOR APPROVAL	JS	LM	AK	30.05.25	DRAWING NOT TO BE USED FOR CONSTRUCTION	THE COPYRIGHT OF THIS DRAWING REMAINS WITH	SCALE 1:500@ A				_

Newcastle
Level 1, 215 Pacific Hwy, Charlestown NSW 2290
Ph (02) 4943 1777 Email newcastle@northrop.com.au
ABN 81 094 433 100

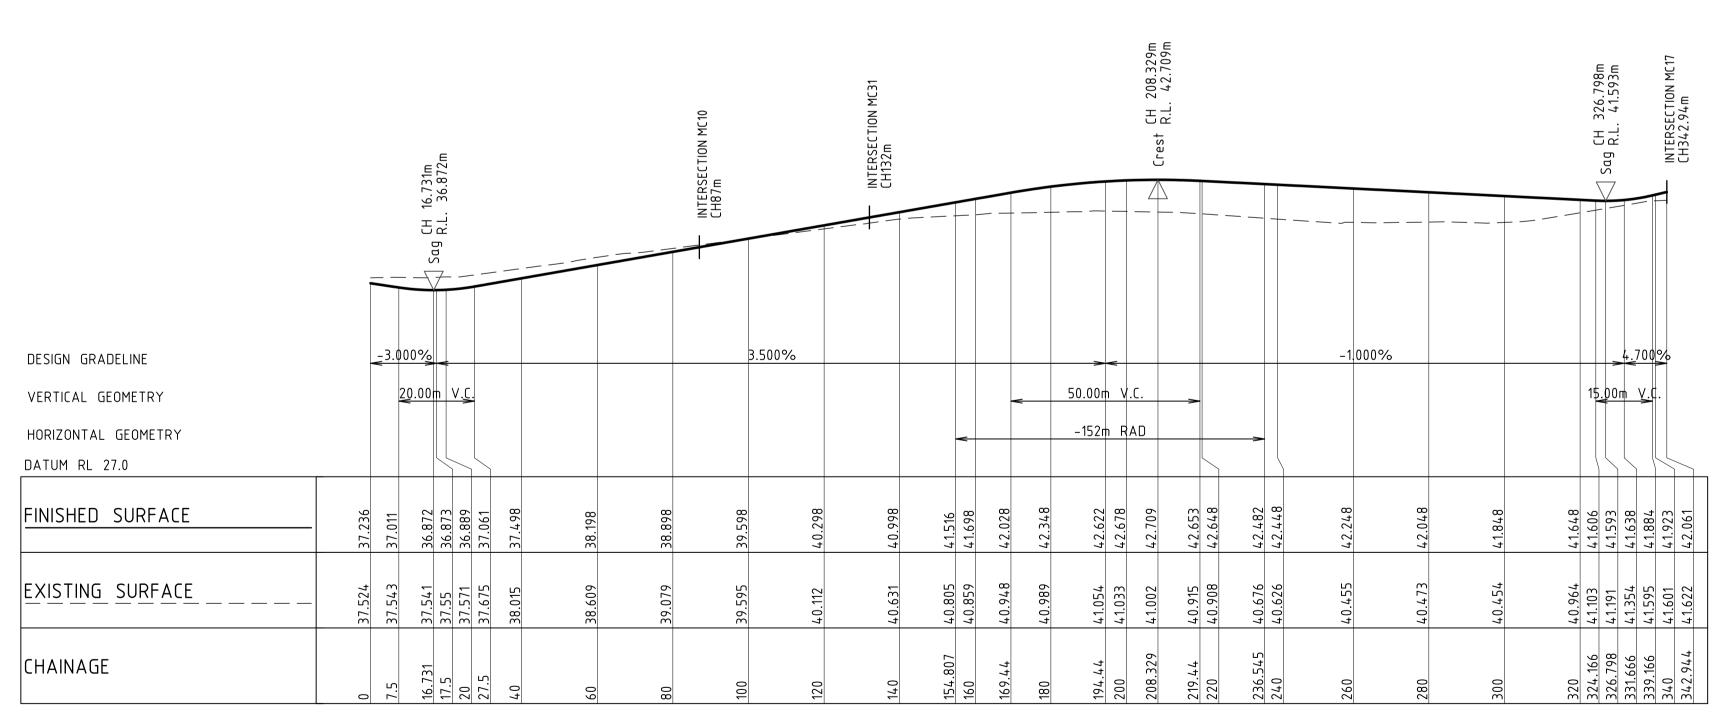FUTURE STAGE



DESIGN GRADELINE 1<u>5.00m V.</u>C 40.00m V.C. VERTICAL GEOMETRY _-118.5m RAD HORIZONTAL GEOMETRY DATUM RL 15.0 FINISHED SURFACE 26.457 26.201 26.004 25.351 25.215 EXISTING SURFACE 25.947 25.815 25.297 25.167 CHAINAGE 70.825 75.936 80

LONGITUDINAL SECTION ALONG MC05

HORIZONTAL SCALE 1:1000@A1 VERTICAL SCALE 1:200@A1

LONGITUDINAL SECTION ALONG MC07 HORIZONTAL SCALE 1:1000@A1

VERTICAL SCALE 1:200@A1

DRAWING TITLE



NOT FOR CONSTRUCTION

REVISION	DESCRIPTION	ISSUED	VER'D	APP'D	DATE
Α	DRAFT ISSUE	JS	-	AK	07.08.24
В	DRAFT ISSUE	JS	1	AK	16.08.24
С	ISSUED FOR APPROVAL	JS	LM	AK	22.08.24
D	DRAFT ISSUE	JS	-	AK	16.05.25
Е	REISSUED FOR APPROVAL	JS	LM	AK	30.05.25
			1		

DRAWING NOT TO BE USED FOR CONSTRUCTION UNLESS VERIFICATION SIGNATURE HAS BEEN ADDED

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OMMENCING WORK. NORTHROP ACCEPTS NO RESPONSIBILITY FOR THE USABILITY, COMPLETENESS OR SCALE OF DRAWINGS TRANSFERRED ELECTRONICALLY. THIS DRAWING MAY HAVE BEEN PREPARED USING COLOUR,
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ABN 81 094 433 100

STAGE 1 DA

PROPOSED SUBDIVISION **559 ANAMBAH ROAD GOSFORTH NSW 2320**

CIVIL ENGINEERING PACKAGE

ROAD LONGITUDINAL SECTIONS -SHEET 3

NL222055-01 DRAWING NUMBER DA1-C05.33

DRAWING SHEET SIZE = A1



REVISION DESCR A DRAFT
B DRAFT
C ISSUED
D DRAFT E REISSUED FOR APPROVAL JS LM AK 30.05.25

DRAWING NOT TO BE USED FOR CONSTRUCTION UNLESS VERIFICATION SIGNATURE HAS BEEN ADDED

THE COPYRIGHT OF THIS DRAWING REMAINS WITH NORTHROP CONSULTING ENGINEERS PTY LTD

SCALE 1:100 @ A1

DESIGN GRADELINE

DATUM RL 18.0

CHAINAGE

VERTICAL GEOMETRY

HORIZONTAL GEOMETRY

FINISHED SURFACE

EXISTING SURFACE

PROPOSED SUBDIVISION

559 ANAMBAH ROAD GOSFORTH NSW 2320

DRAWING TITLE

40.00m V.C.

LONGITUDINAL SECTION ALONG MC11

HORIZONTAL SCALE 1:1000@A1

VERTICAL SCALE 1:200@A1

CIVIL ENGINEERING PACKAGE **ROAD LONGITUDINAL SECTIONS -**

NL222055-01 DRAWING NUMBER

YOU DIG

NOT FOR CONSTRUCTION

5.000%

SCRIPTION	ISSUED VER'D	APP'D DA	TE CLIENT	COUNCIL	ALL DIMENSIONS TO BE VERIFIED ON SITE BEFORE COMMENCING WORK.	P	R
AFT ISSUE	JS -	AK 07.08	3.24		NORTHROP ACCEPTS NO RESPONSIBILITY FOR THE USABILITY, COMPLETENESS OR SCALE OF DRAWINGS	NORTHROPI	
AFT ISSUE	JS -	AK 16.08	224		TRANSFERRED ELECTRONICALLY.	MONTHINO	
SUED FOR APPROVAL	JS LM	AK 22.08		maitland	THIS DRAWING MAY HAVE BEEN PREPARED USING COLOUR, AND MAY BE INCOMPLETE IF COPIED TO BLACK & WHITE.	Newcastle	
AFT ISSUE	JS -	AK 16.05	COMMUNITIES	city council	0 5 10 15 20 25m	Level 1, 215 Pacific Hwy, Charlestown NSW 2290	

Ph (02) 4943 1777 Email newcastle@northrop.com.au ABN 81 094 433 100

20.00m V.<u>C</u>.

0 7.05 12.267 17.05 20 27.05

STAGE 1 DA

SHEET 4

DA1-C05.34 DRAWING SHEET SIZE = A1

																						— INTERSECTION MC05	CH254.68m
		v MC01)7m 235m	JII(557																			
		INTERSECTION MC01 CH0.13m																					
DESIGN GRADELINE VERTICAL GEOMETRY HORIZONTAL GEOMETRY DATUM RL 16.0			882 <u>%</u> 20.00	0m V	<u>C.</u>		8.	000%		•	60.00m	V.C.		->	5.00	00%		•	50.00m		3.000%	->	
FINISHED SURFACE	25.525	25,312	25.235	25.296 25.38	25.824	26.831	28.431	30.031	30.695	31.597	32.87	27.70	34.163	34.595	35.18	36 18	36.737	37.164	37.862	38.013	38.702 38.737	39.143	
EXISTING SURFACE	25.46	25 981	26.236	26.495 26.692	27.253	28.16	29.546	30.793	31.229	31.764	32.601	22.003	33.716	34.19	34.794	35 856	36.447	36.918	37.753	37.919	38.757	39.259	
CHAINAGE	0	607.	12.707	17.409	27.409	07	09	08	88.303	100	118.303	0.71	140	148.303	160	180	191.134	200	216.134	077	240 241.134	254.684	

LONGITUDINAL SECTION ALONG MC10 HORIZONTAL SCALE 1:1000@A1

VERTICAL SCALE 1:200@A1


YOU DIG

REVISION DESCRIPTION ISSUED VER'D APP'D DATE PROPOSED SUBDIVISION NL222055-01 CIVIL ENGINEERING PACKAGE NORTHROP ACCEPTS NO RESPONSIBILITY FOR THE USABILITY, COMPLETENESS OR SCALE OF DRAWINGS - AK 07.08.24 A DRAFT ISSUE **559 ANAMBAH ROAD** B DRAFT ISSUE AK 16.08.24 TRANSFERRED ELECTRONICALLY. THIS DRAWING MAY HAVE BEEN PREPARED USING COLOUR,
AND MAY BE INCOMPLETE IF COPIED TO BLACK & WHITE. DRAWING NUMBER **GOSFORTH NSW 2320** JS LM AK 22.08.24 C ISSUED FOR APPROVAL maitland city council Newcastle **ROAD LONGITUDINAL SECTIONS -**- AK 16.05.25 DA1-C05.35 D DRAFT ISSUE Level 1, 215 Pacific Hwy, Charlestown NSW 2290 SHEET 5 Ph (02) 4943 1777 Email newcastle@northrop.com.au E REISSUED FOR APPROVAL JS | LM | AK | 30.05.25 STAGE 1 DA DRAWING NOT TO BE USED FOR CONSTRUCTION THE COPYRIGHT OF THIS DRAWING REMAINS WITH SCALE 1:100 @ A1 ABN 81 094 433 100 NORTHROP CONSULTING ENGINEERS PTY LTD UNLESS VERIFICATION SIGNATURE HAS BEEN ADDED DRAWING SHEET SIZE = A1


LONGITUDINAL SECTION ALONG MC17
HORIZONTAL SCALE 1:1000@A1

VERTICAL SCALE 1:200@A1

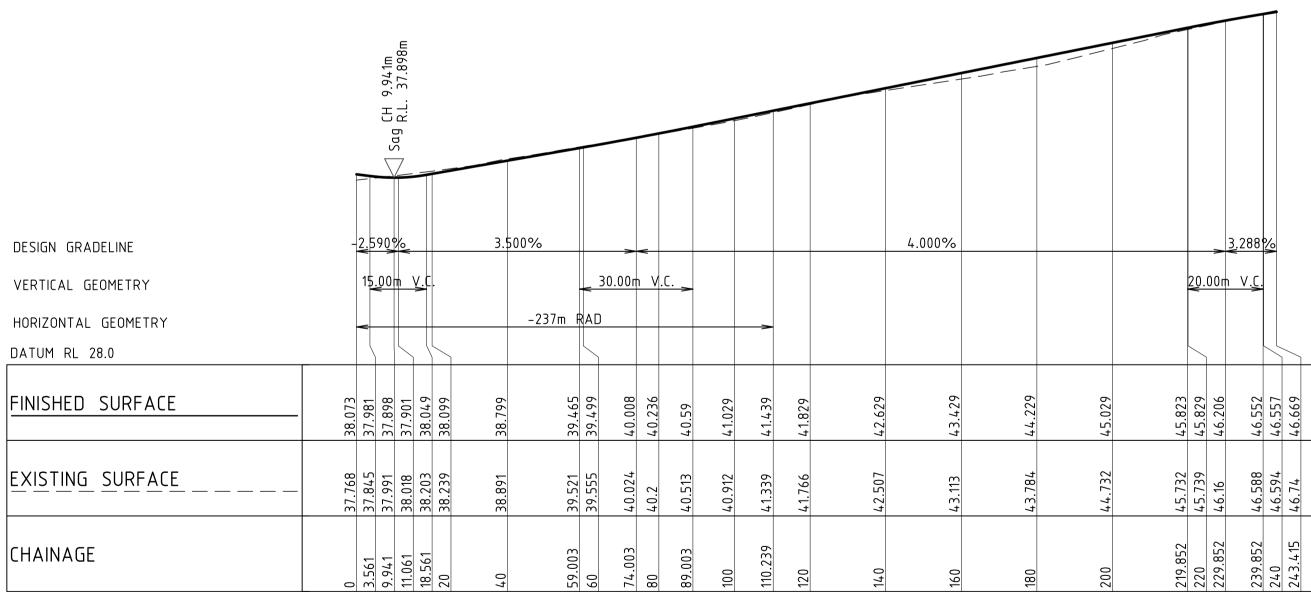STAGE 1



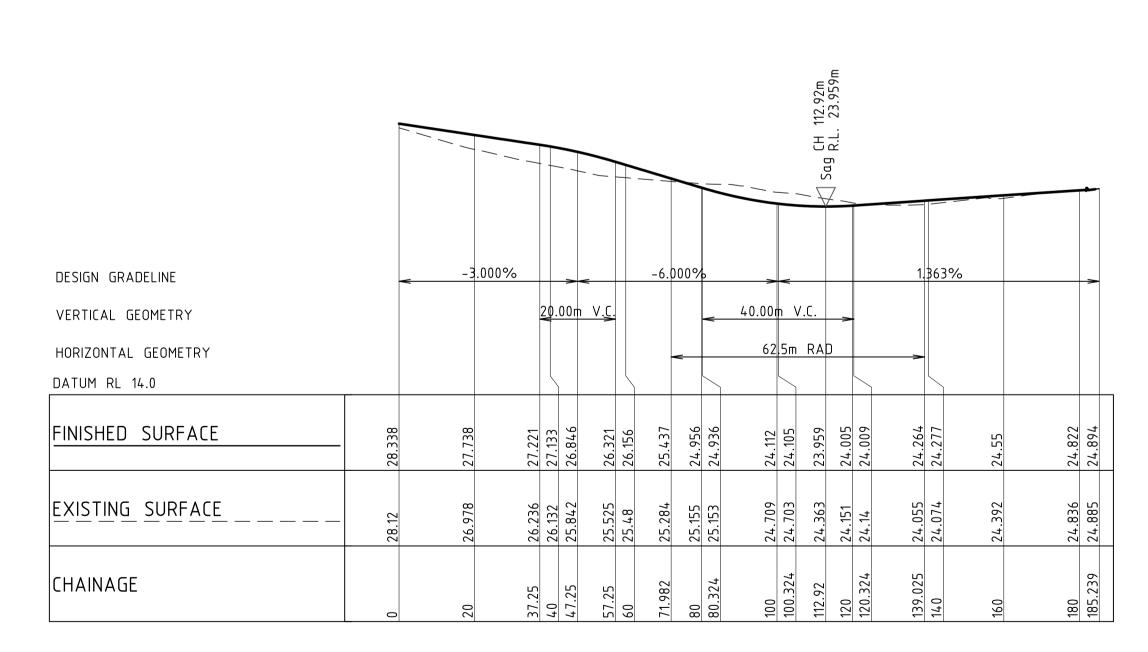LONGITUDINAL SECTION ALONG MC18 HORIZONTAL SCALE 1:1000@A1 VERTICAL SCALE 1:200@A1



LONGITUDINAL SECTION ALONG MC24 HORIZONTAL SCALE 1:1000@A1

VERTICAL SCALE 1:200@A1



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REVISION	DESCRIPTION	ISSUED	VER'D	APP'D	DATE
Α	DRAFT ISSUE	JS	ı	AK	07.08.24
В	DRAFT ISSUE	JS	ı	AK	16.08.24
С	ISSUED FOR APPROVAL	JS	LM	AK	22.08.24
D	DRAFT ISSUE	JS	-	AK	16.05.25
Е	REISSUED FOR APPROVAL	JS	LM	AK	30.05.25

DRAWING NOT TO BE USED FOR CONSTRUCTION

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maitland
city council

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USABILITY, COMPLETENESS OR SCALE OF DRAWINGS
TRANSFERRED ELECTRONICALLY.
THIS DRAWING MAY HAVE BEEN PREPARED USING COLOUR,
AND MAY BE INCOMPLETE IF COPIED TO BLACK & WHITE.

SCALE 1:500@A1

SCALE 1:100@A1

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ABN 81 094 433 100

PROPOSED SUBDIVISION 559 ANAMBAH ROAD GOSFORTH NSW 2320

STAGE 1 DA

CIVIL ENGINEERING PACKAGE

ROAD LONGITUDINAL SECTIONS -

SHEET 6

JOB NUMBER

NL222055-01

DRAWING NUMBER

R

DA1-C05.36

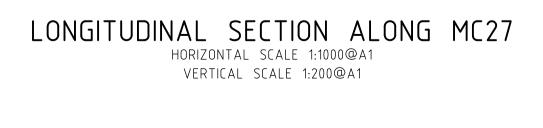
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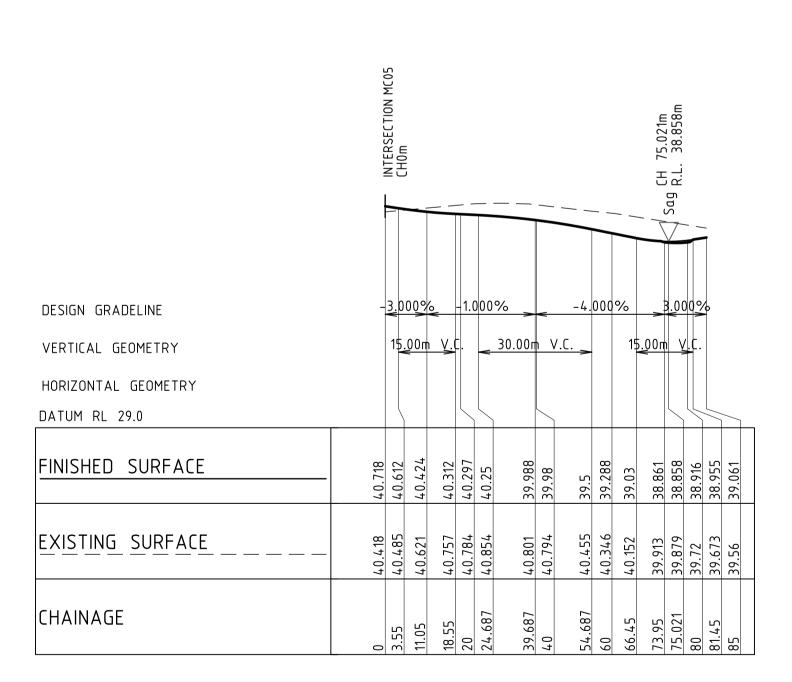
-2.983% DESIGN GRADELINE VERTICAL GEOMETRY HORIZONTAL GEOMETRY DATUM RL 16.0 FINISHED SURFACE EXISTING SURFACE CHAINAGE

15.00m V.C

38.442 38.333 38.079 37.677 37.266

31.5m RAD





LONGITUDINAL SECTION ALONG MC31

HORIZONTAL SCALE 1:1000@A1

VERTICAL SCALE 1:200@A1

STAGE 1 FUTURE STAGE





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A DRAFT ISSUE	JS - AK	07.08.24			NORTHROP ACCEPTS NO RESPONSIBILITY FOR THE	NORTHROD	PROPOSED SUBDIVISION	CIVIL ENGINEERING PACKAGE	NL222055-0
B DRAFT ISSUE	JS – AK	16.08.24	'I hira i		TRANSFERRED ELECTRONICALLY.		559 ANAMBAH ROAD		
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E REISSUED FOR APPROVAL	JS LM AK	30.05.25	DRAWING NOT TO BE USED FOR CONSTRUCTION	THE COPYRIGHT OF THIS DRAWING REMAINS WITH	SCALE 1:500@A1	Ph (02) 4943 1777 Email newcastle@northrop.com.au	STAGE 1 DA	SHEET 7	DA1 303.31
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NOTES

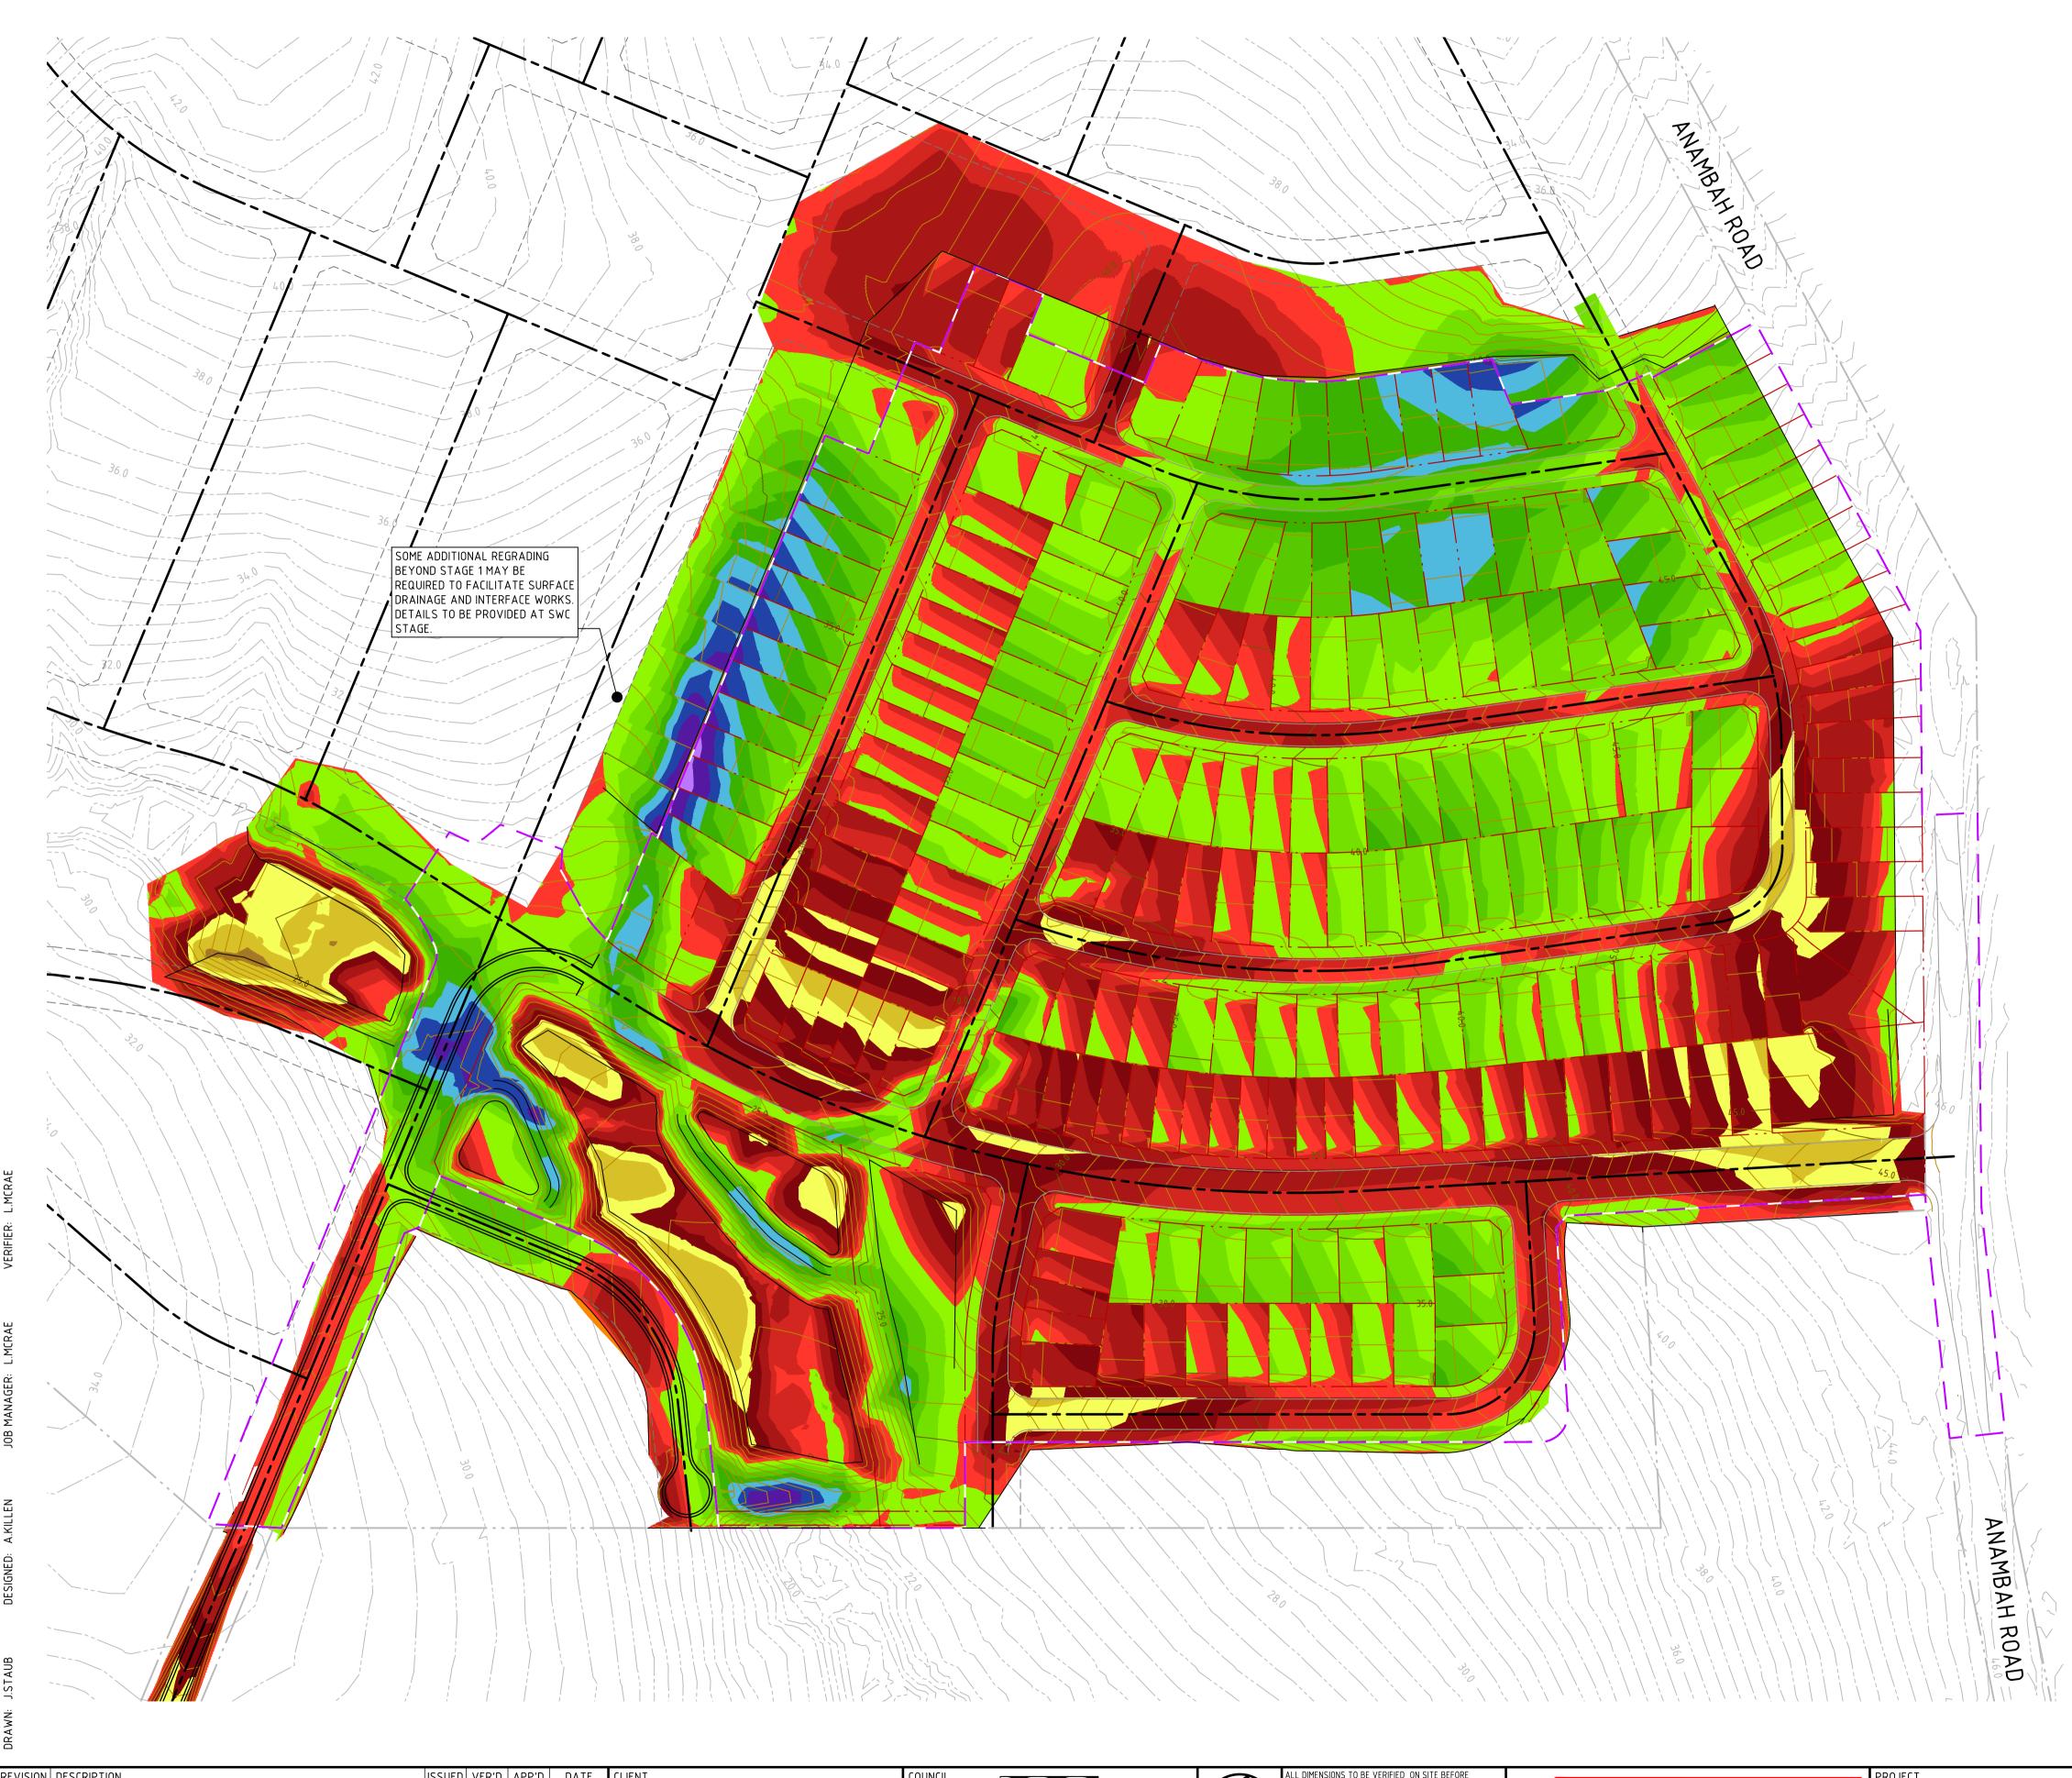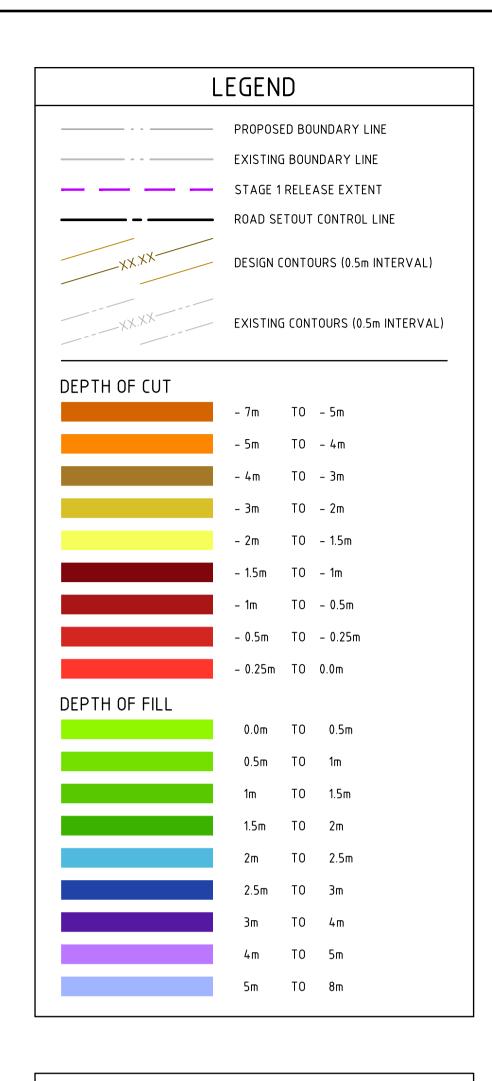BULK EARTHWORKS DEPICTED ARE INDICATIVE ONLY AND IT IS EXPECTED THAT ADDITIONAL AREAS OF CUT AND FILLING WILL BE REQURIED AND THAT LEVELS/DEPTHS OF CUT AND FILL WILL BE ALTERED AND THIS WILL BE CONFIRMED AS PART OF THE DETAILED DESIGN PHASE FOR SUBDIVISION WORKS CERTIFICATE PLAN PREPARATION.



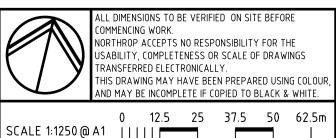
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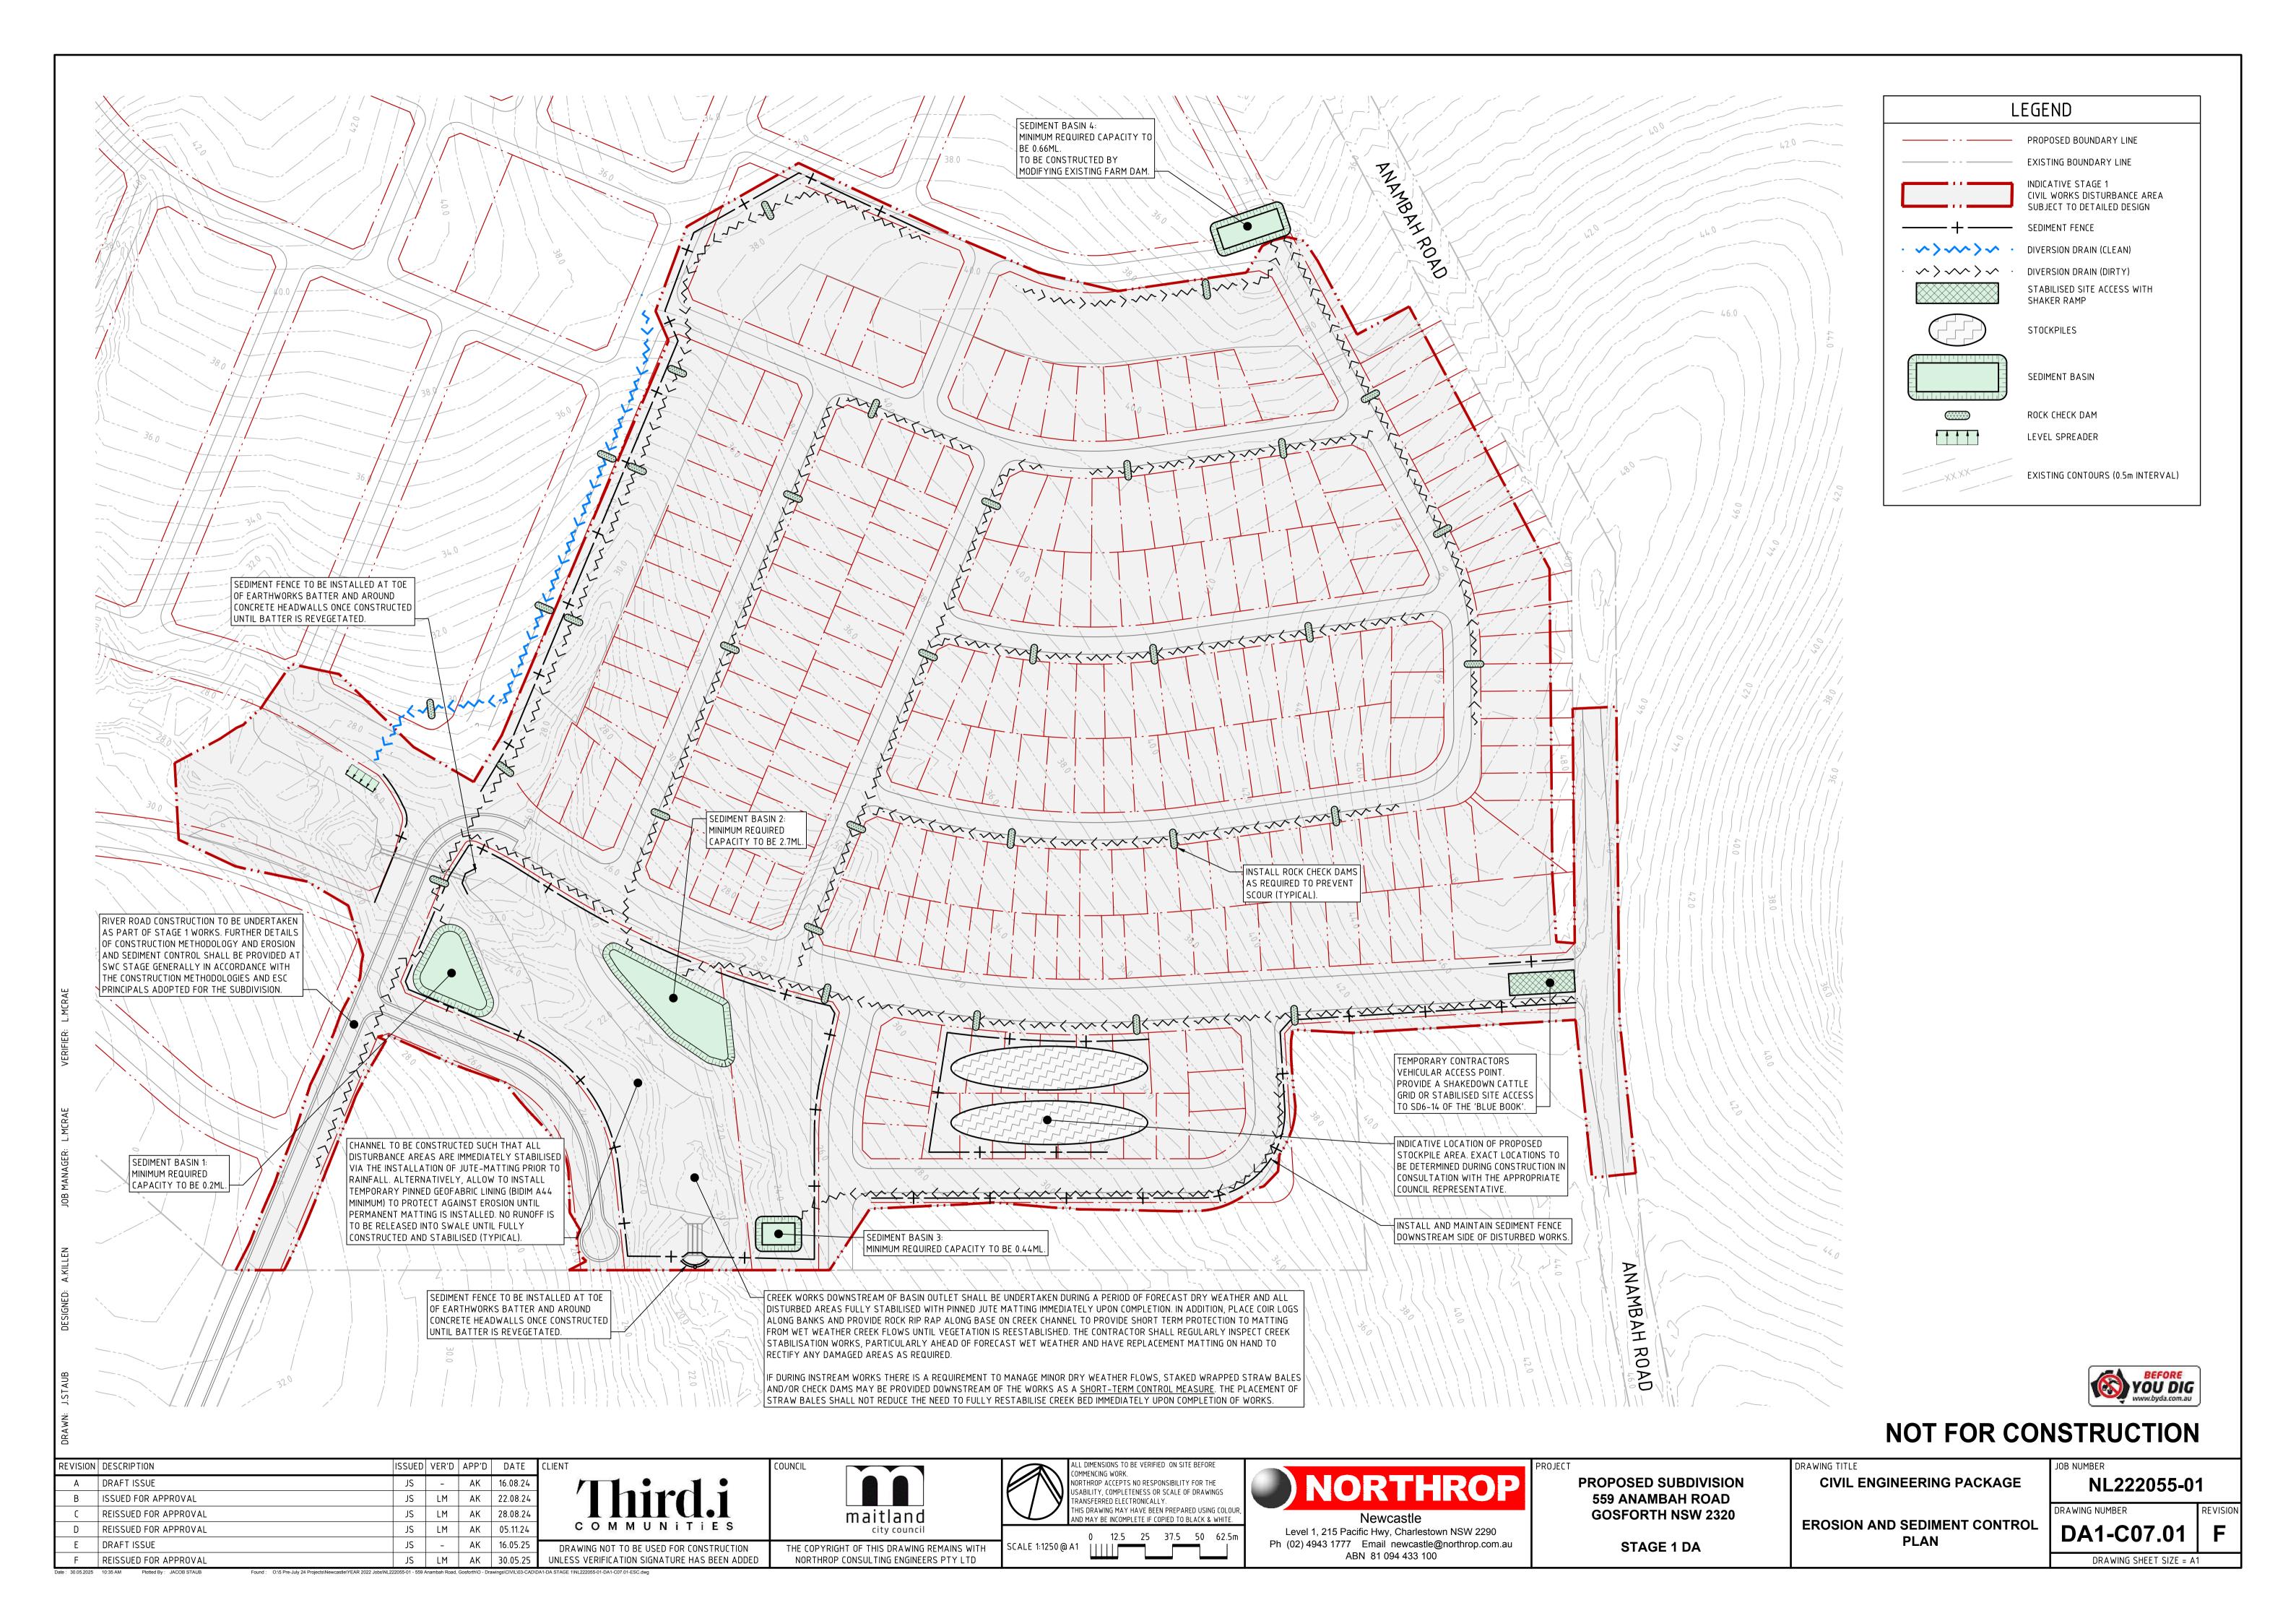
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CONCEPT BULK EARTHWORKS PLAN

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SOIL AND WATER MANAGEMENT

- 1. ALL WORK IS TO BE CARRIED OUT IN ACCORDANCE WITH RELEVANT ORDINANCES AND REGULATIONS; NOTE IN PARTICULAR THE REQUIREMENTS OF LANDCOMS MANAGING URBAN STORMWATER, SOILS AND CONSTRUCTION' (THE BLUE
- 2. THE CONTRACTOR MUST NOTIFY COUNCIL WITHIN 5 WORKING DAYS OF THE INITIAL EROSION CONTROL MEASURES BEING INSTALLED AND CHECK / MAINTAIN THE INSTALLED CONTROL MEASURES DAILY.
- INSTALL SEDIMENT PROTECTION FILTERS ON ALL NEW AND EXISTING STORMWATER INLET PITS IN ACCORDANCE WITH EITHER THE MESH AND GRAVEL INLET FILTER DETAIL SD6-11 OR THE GEOTEXTILE INLET FILTER DETAIL SD6-12 OF THE 'BLUE
- 4. ESTABLISH ALL REQUIRED SEDIMENT FENCES IN ACCORDANCE WITH DETAIL SD6-8 OF THE 'BLUE BOOK'.
- INSTALL SEDIMENT FENCING AROUND INDIVIDUAL BUILDING ZONES / AREAS AS REQUIRED AND AS DIRECTED BY THE SUPERINTENDENT.
- 6. ALL TRENCHES AND SWALE EXCAVATION SHALL BE SIDE-CAST TO THE HIGH SIDE AND CLOSED AT THE END OF EACH DAYS
- 7. THE CONTRACTOR SHALL ENSURE THAT ALL VEGETATION (TREE, SHRUB & GROUND COVER) WHICH IS TO BE RETAINED SHALL BE PROTECTED THROUGH THE DURATION OF CONSTRUCTION. REFER ARCHITECTS PLANS FOR TREES TO BE
- 8. ALL VEGETATION TO BE REMOVED SHALL BE MULCHED ONSITE AND SPREAD/STOCKPILED AS DIRECTED BY THE SUPERINTENDENT.
- 9. STRIP TOPSOIL IN AREAS DESIGNATED FOR STRIPPING AND STOCKPILE FOR RE-USE AS REQUIRED. ANY SURPLUS MATERIAL SHALL BE REMOVED FROM SITE AND DISPOSED OF IN ACCORDANCE WITH EPA GUIDELINES.
- 10. CONSTRUCT AND MAINTAIN ALL MATERIAL STOCKPILES IN ACCORDANCE WITH DETAIL SD4-1 OF THE 'BLUE BOOK' (INCLUDING CUT-OFF SWALES TO THE HIGH SIDE AND SEDIMENT FENCES TO THE LOW SIDE). NOTABLY, ENSURE STOCKPILES DO NOT EXCEED 2.0m HIGH. IF MATERIALS ARE LIKELY TO BE STOCKPILED FOR MORE THAN 10 DAYS, THE CONTRACTOR SHALL PROVIDE AN APPROPRIATE PROTECTIVE COVER (SYNTHETIC OR ORGANIC).
- 11. PROVIDE WATER TRUCKS OR SPRINKLER DEVICES DURING CONSTRUCTION AS REQUIRED TO SUPPRESS DUST. WHERE COUNCIL CONSIDERS THAT THE DUST IS NOT ADEQUATELY CONTROLLED, THE CONTRACTOR MUST INVESTIGATE OTHER DUST MITIGATION MEASURES SUCH AS DUST SUPPRESSANTS. THE CONTRACTOR MUST ENSURE THE CHEMICAL BASED DUST SUPPRESSANT DOES NOT CREATE A TRAFFIC OR ENVIRONMENTAL HAZARD.
- 12. SHOULD ANY SEDIMENT LADEN WATER LEAVE THE SITE, THE INCIDENT MUST BE REPORTED TO COUNCIL WITHIN 2 HOURS OF THE SITE MANAGER BECOMING AWARE OF THE INCIDENT.
- 13. THE CONTRACTOR SHALL BE RESPONSIBLE FOR KEEPING A DETAILED WRITTEN RECORD OF ALL EROSION & SEDIMENT CONTROLS ON-SITE DURING THE CONSTRUCTION PERIOD. THIS RECORD SHALL BE UPDATED ON A WEEKLY BASIS & SHALL CONTAIN DETAILS ON THE CONDITION OF CONTROLS AND ANY / ALL MAINTENANCE, CLEANING & BREACHES. THIS RECORD SHALL BE KEPT ON-SITE AT ALL TIMES AND SHALL BE MADE AVAILABLE FOR INSPECTION BY THE PRINCIPAL CERTIFYING AUTHORITY AND THE SUPERINTENDENT DURING NORMAL WORKING HOURS.
- 14. MEASURES USED TO CONTROL WIND EROSION MUST BE APPROPRIATE FOR THE LOCATION AND PREVENT SOIL EROSION AT ALL TIMES, INCLUDING WORK HOURS, WEEKENDS, PUBLIC HOLIDAYS AND DURING ANY OTHER SHUTDOWN PERIODS.
- 15. ONCE CUT / FILL OPERATIONS HAVE BEEN FINALISED ALL DISTURBED AREAS THAT ARE NOT BEING WORKED ON SHALL BE RE-VEGETATED AS SOON AS IS PRACTICAL.
- 16. PRIORITY MUST BE GIVEN TO THE PREVENTION, OR AT LEAST MINIMISATION, OF SOIL EROSION, RATHER THAN THE TRAPPING OF DISPLACED SEDIMENT. SUCH A CLAUSE SHALL NOT REDUCE THE RESPONSIBILITY OF A CONTRACTOR TO APPLY AND MAINTAIN, AT ALL TIMES, ALL NECESSARY SEDIMENT CONTROL MEASURES.
- 17. ALL EROSION AND SEDIMENTATION CONTROL MEASURES MUST BE APPROPRIATE FOR THE SEDIMENT TYPE(S) OF THE SOILS ON-SITE, IN ACCORDANCE WITH THE 'BLUE BOOK' (MANAGING URBAN STORMWATER - SOILS AND CONSTRUCTION. LANDCOM, 2004), OR OTHER CURRENT RECOGNISED INDUSTRY STANDARDS FOR EROSION AND SEDIMENT CONTROL FOR AUSTRALIAN CONDITIONS. THIS INCLUDES SEDIMENT TRAPS AND LINING OF CHANNELS.

CONSTRUCTION SEQUENCE

- INSTALL SEDIMENT FENCING AND CUT DRAINS TO MEET THE REQUIREMENTS OF THE SEDIMENT AND EROSION CONTROL PLAN AND MAITLAND CITY COUNCIL'S REQUIREMENTS.
- CONSTRUCT STABILISED SITE ACCESS.
- 3. REDIRECT CLEAN WATER AROUND THE CONSTRUCTION SITE.
- 4. INSTALL SEDIMENT CONTROL PROTECTION MEASURES AT NATURAL AND MAN-MADE DRAINAGE STRUCTURES. MAINTAIN UNTIL ALL THE DISTURBED AREAS ARE STABILISED.
- 5. CLEAR AND STRIP THE WORK AREAS. MINIMISE THE DAMAGE TO GRASS AND LOW GROUND COVER OF NON-DISTURBED AREAS.
- 6. ANY DISTURBED AREAS, OTHER THAN ROAD PAVEMENT AREAS. SHALL BE COVERED WITH SITE TOPSOIL AND SEEDED WITHIN 7 DAYS OF COMPLETION OF BULK LEVELS.
- 7. APPLY PERMANENT STABILISATION TO SITE (LANDSCAPING).

GENERAL NOTES

- THE CONTRACTOR SHALL PROVIDE BARRIER / PERSON PROOF FENCE TO THE SITE / THEIR COMPOUND TO ENSURE THE SITE IS MADE SAFE TO THE PUBLIC FOR THE DURATION OF CONSTRUCTION.
- 2. THE SEDIMENT AND EROSION CONTROL MEASURES SHOWN ON THIS PLAN ARE GENERAL SITE MEASURES. ADDITIONAL MEASURES MAY BE REQUIRED AROUND INDIVIDUAL BUILDING ZONES DEPENDENT ON THE SEQUENCE OF CONSTRUCTION.

GROUND COVER FACTORS

THE LONG TERM GROUND COVER FACTORS FOR THE CONSTRUCTION WORKS IS NOT TO EXCEED THE FOLLOWING LIMITS:

LAND	MAXIMUM C-FACTOR	REMARKS
WATERWAYS AND OTHER AREAS OF CONCENTRATED FLOWS, POST CONSTRUCTION	0.05	APPLIES AFTER TEN WORKING DAYS OF COMPLETION OF FORMATION AND BEFORE CONCENTRATED FLOWS ARE APPLIED. FOOT AND VEHICULAR TRAFFIC IS PROHIBITED IN THIS AREA AND 70% GROUND COVER IS REQUIRED.
STOCKPILES, POST CONSTRUCTION	0.10	APPLIES AFTER TEN WORKING DAYS FROM COMPLETION OF FORMATION. 60% GROUND COVER IS REQUIRED.
ALL LANDS, INCLUDING WATERWAYS AND STOCKPILES, DURING CONSTRUCTION	0.15	APPLIES AFTER 20 DAYS OF INACTIVITY, EVEN THOUGH WORKS MAY BE INCOMPLETE. 50% GROUND COVER IS REQUIRED.

BASIN MANAGEMENT NOTES

- 1. PRIOR TO ANY FORECAST WEATHER EVENT, LIKELY TO RESULT IN SEDIMENT LADEN RUNOFF ON THE SITE, ANY EXISTING DETENTION BASINS/TRAPS SHALL BE DEWATERED TO PROVIDE SUFFICIENT CAPACITY TO CAPTURE SEDIMENT LADEN WATER FROM THE SITE.
- 2. ANY SEDIMENT LADEN WATER CAPTURED ON-SITE MUST BE TREATED TO ENSURE IT WILL ACHIEVE COUNCIL'S WATER QUALITY OBJECTIVES PRIOR TO ITS RELEASE FROM SITE. A SAMPLE OF THE RELEASED TREATED WATER MUST BE KEPT ON-SITE IN A CLEAR CONTAINER WITH THE SAMPLE DATE RECORDED.
- 3. NO ALUMINIUM BASED PRODUCTS MAY BE USED TO TREAT TURBID WATER (FLOCCULATING/COAGULANTS) ON-SITE WITHOUT THE PRIOR WRITTEN PERMISSION FROM AN APPROPRIATE COUNCIL OFFICER. THE APPLICANT MUST HAVE DEMONSTRATED ABILITY TO USE SUCH PRODUCTS CORRECTLY AND WITHOUT ENVIRONMENTAL HARM PRIOR TO ANY APPROVAL.
- 4. THE CHEMICAL/AGENT (FLOCCULATING/COAGULANTS) USED IN TYPE D AND TYPE F BASINS TO TREAT TURBID WATER CAPTURED IN THE BASIN MUST BE APPLIED IN CONCENTRATIONS SUFFICIENT TO ACHIEVE COUNCIL'S WATER QUALITY OBJECTIVES (TSS < 50mg/L, TURBIDITY < 60 NTU, 6.5 < pH < 8.5) WITHIN THE 5-DAY RAINFALL DEPTH USED TO CALCULATE THE CAPACITY OF THE BASIN, AFTER A RAINFALL EVENT.
- 5. ALL MANUFACTURERS INSTRUCTIONS MUST BE FOLLOWED FOR THE USE OF ANY CHEMICALS/AGENTS USED ON-SITE, EXCEPT WHERE APPROVED BY THE RESPONSIBLE PERSON OR AN APPROPRIATE COUNCIL OFFICER.
- 6. SUFFICIENT QUANTITIES OF CHEMICALS/AGENTS TO TREAT TURBID WATER (FLOCCULATING/COAGULANTS) MUST BE PLACED SUCH THAT WATER ENTERING THE BASINS/SEDIMENT TRAP MIXES WITH THE CHEMICALS/AGENTS AND IS CARRIED INTO THE BASIN/TRAP.
- 7. ANY BASIN MUST BE DEWATERED AS SOON AS PRACTICAL, ONCE WATER CAPTURED IN THE BASIN ACHIEVES COUNCIL'S WATER QUALITY OBJECTIVES.
- 8. INSPECT THE SEDIMENT BASINS AFTER EACH RAINFALL EVENT AND/OR WEEKLY. ENSURE THAT ALL SEDIMENT IS REMOVED ONCE THE SEDIMENT STORAGE ZONE IS FULL. ENSURE THAT OUTLET AND EMERGENCY SPILLWAY WORKS ARE MAINTAINED IN A FULLY OPERATIONAL CONDITION AT ALL TIMES.
- 9. STAGE BASIN CONSTRUCTION TO ENSURE EXISTING STORMWATER SYSTEM DISCHARGE AND NATURAL CREEK RUNOFF REMAINS FREE OF SEDIMENT. PRIOR TO COMMENCEMENT THE CONTRACTOR SHALL PREPARE A MANAGEMENT PLAN DETAILING PROPOSED METHODOLOGY TO MANAGE EXISTING WATERCOURSE FLOWS TO SUIT PROPOSED CONSTRUCTION METHODOLOGY.

SEDIMENT BASINS SIZING CALCULATIONS

TOTAL BAS	SIN VO	LUME (ST	AGE 1 DA)				
LOCATION	Су	5-DAY, 80-%ile	TOTAL CATCHMENT AREA (ha)	DISTURBED CATCHMENT AREA (ha)	SETTLING ZONE VOLUME (m³)	SEDIMENT STORAGE VOLUME (m³)	TOTAL BASIN VOLUME (m³)
SEDIMENT BASIN 1	0.56	30.0	1.0	1.28	215	40	200
SEDIMENT BASIN 2	0.56	30.0	12.5	12.5	2100	489	2700
SEDIMENT BASIN 3	0.56	30.0	2.2	1.89	318	58	440
SEDIMENT BASIN 4	0.56	30.0	3.3	3.61	606	127	660

THE SITE IS LOCATED WITHIN THE BRANXTON AND ROTHBURY SOIL LANDSCAPE, WHICH HAS THE FOLLOWING PROPERTIES (BASED ON SITE SPECIFIC GEOTECH REPORT #EP3627.002 PREPARED BY EP RISK"

- PRIMARILY SILTY AND SANDY CLAYS
- SEDIMENT TYPE D
- SOIL HYDROLOGY GROUP D
- K-FACTOR OF 0.050 (ROTHBURY AND BRANXTON SOIL LANDSCAPE)

THE SIZING OF THE SEDIMENT STORAGE VOLUME OF THE SITES PROPOSED SEDIMENTATION BASINS WERE CALCULATED BY APPLYING THE REVISED UNIVERSAL SOIL LOSS EQUATION (RUSLE) METHOD:

SOIL LOSS = R K LS P C

WHERE; R = RAINFALL EROSIVITY FACTOR = 1820

2 YEAR, 6 HOUR STORM INTENSITY = 8.89 mm/hr

LS = SLOPE LENGTH/GRADIENT FACTOR = 2.00-2.53 (VARIES PER BASIN)

K = SOIL ERODIBILITY FACTOR = 0.05

- P = EROSION CONTROL PRACTICE (P-FACTOR) = 1.3 (TYPICAL)
- C = GROUND COVER (C-FACTOR) = 1.0 (TYPICAL FOR STRIPPED SITE)

THE REMAINING VARIABLES ARE PRESENTED WITHIN THE TEMPORARY SEDIMENT BASIN CAPACITY TABLE.

THE SETTLING ZONE VOLUME OF THE BASIN WAS CALCULATED FOR A 2 MONTHS SOIL LOSS AS CALCULATED BY THE RUSLE METHOD:

SETTLING ZONE VOLUME = 10 CV RX-DAY, Y-%ILE x CATCHMENT AREA

WHERE RX-DAY, Y-%TILE = 30.5 mm/hr [5 DAY, 80th PERCENTILE RAINFALL EVENT]



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EROSION AND SEDIMENT CONTROL

NL222055-01 DRAWING NUMBER DA1-C07.11

DRAWING SHEET SIZE = A1

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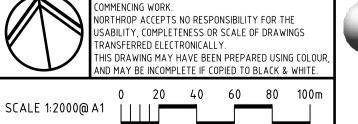
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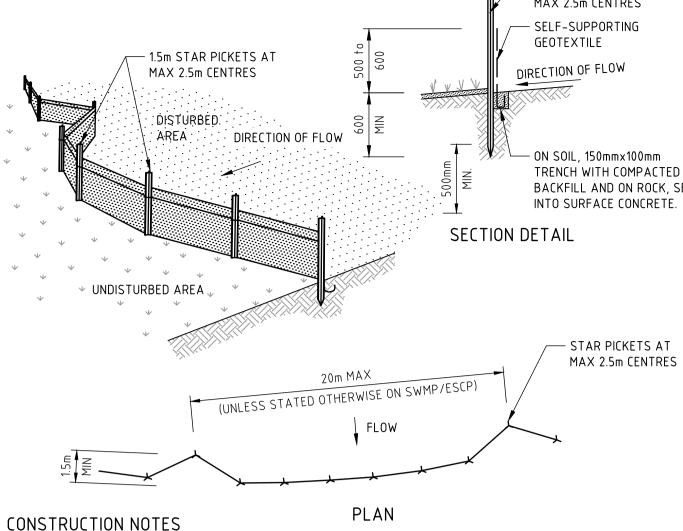
559 ANAMBAH ROAD

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CONSTRUCTION NOTES

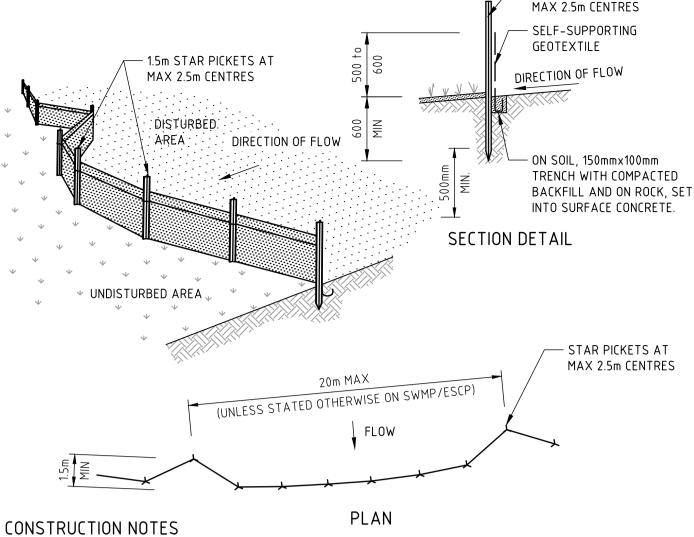
- 1. PLACE STOCKPILES MORE THAN 2m (PREFERABLY 5m) FROM EXISTING VEGETATION, CONCENTRATED WATER FLOW, ROADS AND HAZARD AREAS.
- 2. CONSTRUCT ON THE CONTOUR AS LOW, FLAT, ELONGATED MOUNDS.
- 3. WHERE THERE IS SUFFICIENT AREA, TOPSOIL STOCKPILES SHALL BE LESS THAN 2m IN HEIGHT 4. WHERE THEY ARE TO BE IN PLACE FOR MORE THAN 10 DAYS, STABILISE FOLLOWING THE APPROVED
- ESCP OR SWMP TO REDUCE THE C-FACTOR TO LESS THAN 0.10.
- 5. CONSTRUCT EARTH BANKS (STANDARD DRAWING 5-5) ON THE UPSLOPE SIDE TO DIVERT WATER AROUND STOCKPILES AND SEDIMENT FENCES (STANDARD DRAWING 6-8) 1 TO 2m DOWNSLOPE.

STOCKPILES (SD 4-1)




- 1. CONSTRUCT SEDIMENT FENCES AS CLOSE AS POSSIBLE TO BEING PARALLEL TO THE CONTOURS OF THE ONE SECTION. THE CATCHMENT AREA SHOULD BE SMALL ENOUGH TO LIMIT WATER FLOW IF
- 2. CUT A 150mm DEEP TRENCH ALONG THE UPSLOPE LINE OF THE FENCE FOR THE BOTTOM OF THE FABRIC TO BE ENTRENCHED.
- 3. DRIVE 1.5 METRE LONG STAR PICKETS INTO GROUND AT 2.5 METRE INTERVALS (MAX) AT THE
- 4. FIX SELF-SUPPORTING GEOTEXTILE TO THE UPSLOPE SIDE OF THE POSTS ENSURING IT GOES TO THE BASE OF THE TRENCH. FIX THE GEOTEXTILE WITH WIRE TIES OR AS RECOMMENDED BY THE
- 6. BACKFILL THE TRENCH OVER THE BASE OF THE FABRIC AND COMPACT IT THOROUGHLY OVER THE

SEDIMENT FENCE (SD 6-8)




- SITE, BUT WITH SMALL RETURNS AS SHOWN IN THE DRAWING TO LIMIT THE CATCHMENT AREA OF ANY CONCENTRATED AT ONE POINT TO 50 LITRES PER SECOND IN THE DESIGN STORM EVENT, USUALLY THE 10-YEAR EVENT.
- DOWNSLOPE EDGE OF THE TRENCH. ENSURE ANY STAR PICKETS ARE FITTED WITH SAFETY CAPS.
- MANUFACTURER. ONLY USE GEOTEXTILE SPECIFICALLY PRODUCED FOR SEDIMENT FENCING. THE USE OF SHADE CLOTH FOR THIS PURPOSE IS NOT SATISFACTORY
- 5. JOIN SECTIONS OF FABRIC AT A SUPPORT POST WITH A 150mm OVERLAP.

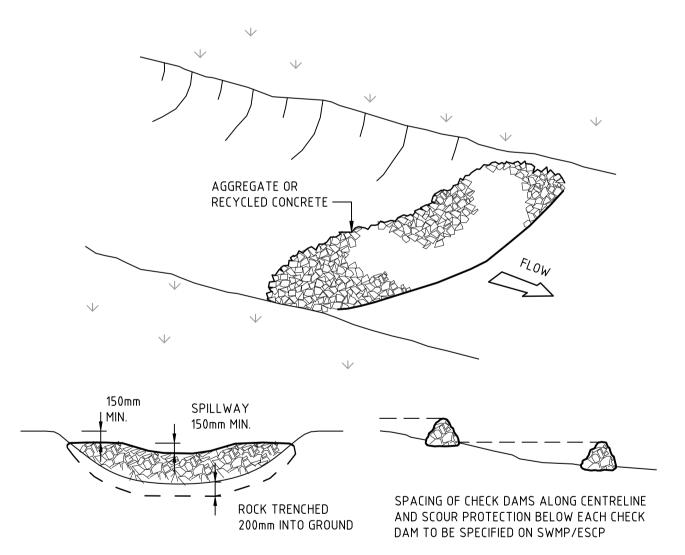

CONSTRUCTION NOTES

- 1. CHECK DAMS CAN BE BUILT WITH VARIOUS MATERIALS, INCLUDING ROCKS, LOGS, SANDBAGS AND STRAW BALES. THE MAINTENANCE PROGRAM SHOULD ENSURE THEIR INTEGRITY IS RETAINED, ESPECIALLY WHERE CONSTRUCTED WITH STRAW BALES. IN THE CASE OF BALES, THIS MIGHT REQUIRE THEIR REPLACEMENT EACH TWO TO FOUR MONTHS.
- 2. TRENCH THE CHECK DAM 200mm INTO THE GROUND ACROSS ITS WHOLE WIDTH. WHERE ROCK IS USED, FILL THE TRENCHES TO AT LEAST 100mm ABOVE THE GROUND SURFACE TO REDUCE THE RISK OF
- UNDERCUTTING. 3. NORMALLY, THEIR MAXIMUM HEIGHT SHOULD NOT EXCEED 600mm ABOVE THE GULLY FLOOR. THE CENTRE SHOULD ACT AS A SPILLWAY, BEING AT LEAST 150mm LOWER THAN THE OUTER EDGES.
- 4. SPACE THE DAMS SO THE TOE OF THE UPSTREAM DAM IS LEVEL WITH THE SPILLWAY OF THE NEXT DOWNSTREAM DAM.

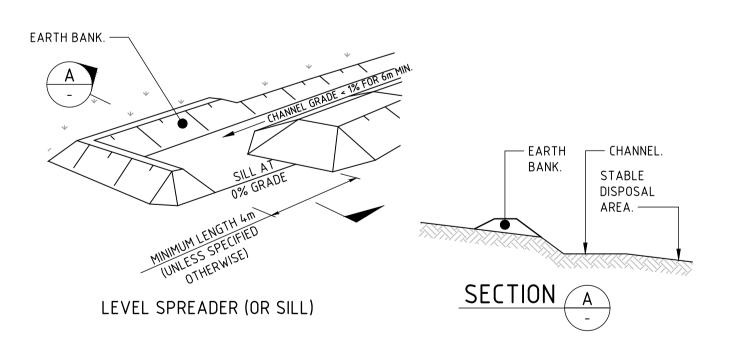
ROCK CHECK DAM (SD 5-4)



CONSTRUCTION NOTES

- 1. CONSTRUCT THE LEVEL SPREADER AT THE GRADIENT SPECIFIED ON THE ESCP OR SWMP, NORMALLY LESS THAN 1 PERCENT OR LEVEL.
- 2. WHERE POSSIBLE, ENSURE THEY DISCHARGE WATERS ONTO EITHER STABILISED OR UNDISTURBED DISPOSAL SITES WITHIN THE SAME SUBCATCHMENT AREA FROM WHICH THE WATER ORIGINATED. APPROVAL MIGHT BE REQUIRED TO DISCHARGE INTO OTHER SUBCATCHMENTS.

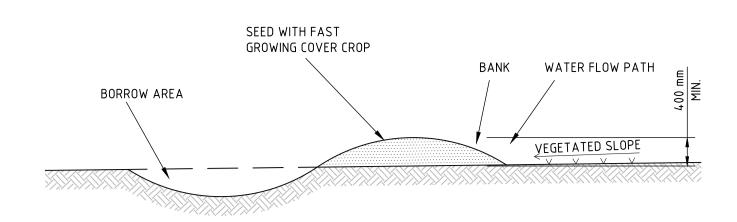LEVEL SPREADER




CONSTRUCTION NOTES

- 1.5m STAR PICKETS AT

- TO BE USED FOR CLEAN WATER DIVERSION DRAINS.
- BORROW AREA TO BE ON DISTURBED (DIRTY) SIDE OF DRAIN. AVOID REMOVING TREES AND SHRUBS IF POSSIBLE - WORK AROUND THEM.
- ENSURE THE STRUCTURES ARE FREE OF PROJECTIONS OR OTHER IRREGULARITIES THAT COULD IMPEDE WATER FLOW.
- BUILD THE DRAINS WITH CIRCULAR, PARABOLIC OR TRAPEZOIDAL CROSS SECTIONS, NOT V SHAPED.
- ENSURE THE BANKS ARE PROPERLY COMPACTED TO PREVENT FAILURE.
- COMPLETE PERMANENT OR TEMPORARY STABILISATION WITHIN 10 DAYS OF CONSTRUCTION.

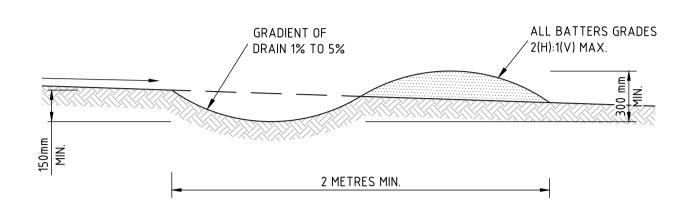
CLEAN WATER DIVERSION SWALE (BACK PUSH BANK)



CONSTRUCTION NOTES

- 1. TO BE USED FOR DIRTY WATER CUT OFF SWALES & CAN BE USED FOR CLEAN WATER DIVERSION DRAINS (IF LINED)
- PROVIDE GEOFABRIC LINING TO SECTIONS OF CLEAN WATER DIVERSION
- BUILD WITH GRADIENTS BETWEEN 1 PERCENT AND 5 PERCENT.
- AVOID REMOVING TREES AND SHRUBS IF POSSIBLE WORK AROUND THEM. ENSURE THE STRUCTURES ARE FREE OF PROJECTIONS OR OTHER IRREGULARITIES THAT COULD IMPEDE
- WATER FLOW.
- 6. BUILD THE DRAINS WITH CIRCULAR, PARABOLIC OR TRAPEZOIDAL CROSS SECTIONS, NOT V SHAPED. ENSURE THE BANKS ARE PROPERLY COMPACTED TO PREVENT FAILURE.
- 8. COMPLETE PERMANENT OR TEMPORARY STABILISATION WITHIN 10 DAYS OF CONSTRUCTION.

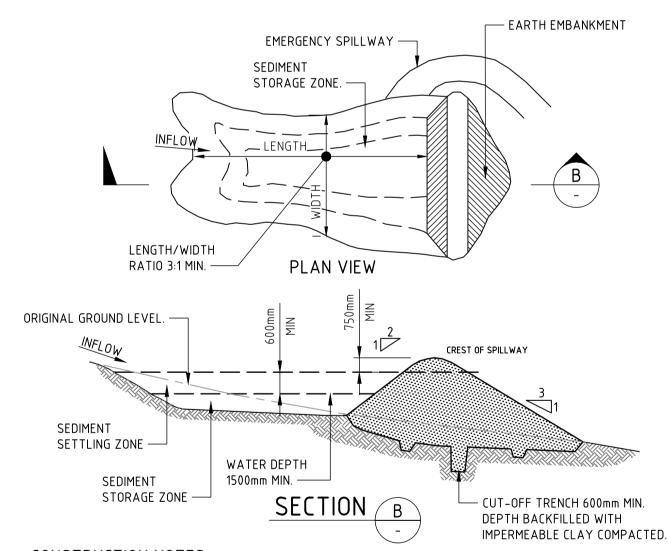DIRTY WATER DIVERSION SWALE




CONSTRUCTION NOTES

- 1. REMOVE ALL VEGETATION AND TOPSOIL FROM UNDER THE DAM WALL AND FROM WITHIN THE STORAGE
- CONSTRUCT A CUT-OFF TRENCH 500mm DEEP AND 1200mm WIDE ALONG THE CENTRELINE OF THE
- EMBANKMENT EXTENDING TO A POINT ON THE GULLY WALL LEVEL WITH THE RISER CREST. MAINTAIN THE TRENCH FREE OF WATER AND RECOMPACT THE MATERIALS WITH EQUIPMENT AS
- SPECIFIED IN THE SWMP TO 95 PER CENT STANDARD PROCTOR DENSITY.
- PREPARE THE SITE UNDER THE EMBANKMENT BY RIPPING TO AT LEAST 100mm TO HELP BOND

4. SELECT FILL FOLLOWING THE SWMP THAT IS FREE OF ROOTS, WOOD, ROCK, LARGE STONE OR FOREIGN


- COMPACTED FILL TO THE EXISTING SUBSTRATE.
- 6. SPREAD THE FILL IN 100mm TO 150mm LAYERS AND COMPACT IT AT OPTIMUM MOISTURE CONTENT
- FOLLOWING THE SWMP.
- 7. CONSTRUCT THE EMERGENCY SPILLWAY. 8. REHABILITATE THE STRUCTURE FOLLOWING THE SWMP.

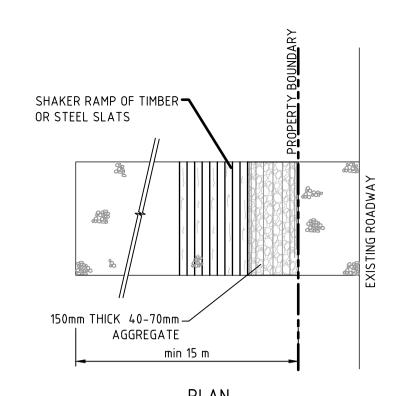(APPLIES TO 'TYPE D' AND 'TYPE F' SOILS ONLY) EARTH SEDIMENT BASIN - WET (SD 6-4)



STABILISED SITE ACCESS WITH SHAKER RAMP




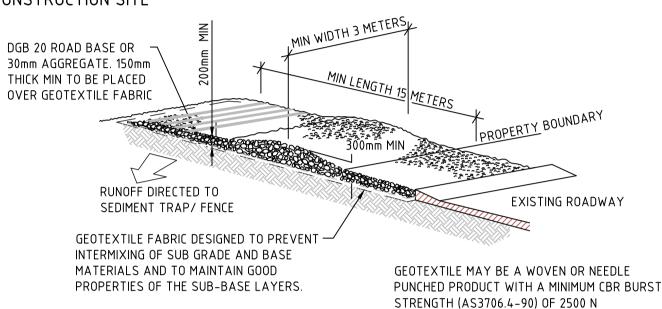

STABILISED SITE ACCESS WITH SHAKER RAMP

STABILISED SITE ACCESS WITH SHAKER RAMP CONSTRUCTION NOTES

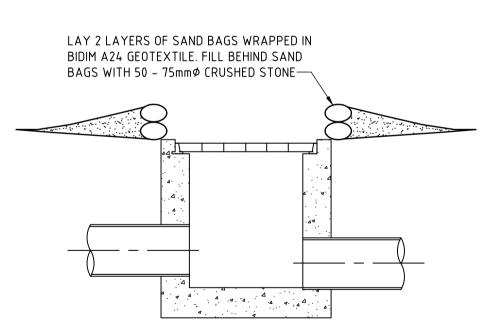- 1. THIS DEVICE IS TO BE LOCATED AT ALL EXITS FROM CONSTRUCTION SITE. 2. THIS DEVICE IS TO BE REGULARLY CLEANED OF DEPOSITED MATERIAL SO AS TO MAINTAIN A
- 50mm DEEP SPACE BETWEEN PLANKS.
- 3. ANY UNSEALED ROAD BETWEEN THIS DEVICE AND NEAREST ROADWAY IS TO BE TOPPED WITH 100mm THICK 40-70mm SIZE AGGREGATE.
- 4. ALTERNATIVELY, PRECAST CONCRETE CATTLE GRIDS MAY BE USED. 1, 2 & 3 ABOVE ALSO



PIT PROTECTION DETAIL (ALTERNATIVE DETAIL SD6-11 OR SD6-12 OF THE BLUE BOOK AS APPROPRIATE)

INSTALL PIT PROTECTION TO ALL NEW & EXISTING STORMWATER PITS

YOU DIG


NOT FOR CONSTRUCTION

Α	DRAFT ISSUE	JS	-	AK	16.08.24
В	ISSUED FOR APPROVAL	JS	LM	AK	22.08.24
С	DRAFT ISSUE	JS	-	AK	16.05.25
D	REISSUED FOR APPROVAL	JS	LM	AK	30.05.25

|ISSUED| VER'D | APP'D | DATE | CLIENT DRAWING NOT TO BE USED FOR CONSTRUCTION





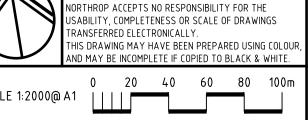



ABN 81 094 433 100

PROPOSED SUBDIVISION **559 ANAMBAH ROAD GOSFORTH NSW 2320**

CIVIL ENGINEERING PACKAGE

EROSION AND SEDIMENT CONTROL DETAILS

NL222055-01

DRAWING NUMBER DA1-C07.12

DRAWING SHEET SIZE = A1

D

REVISION DESCRIPTION

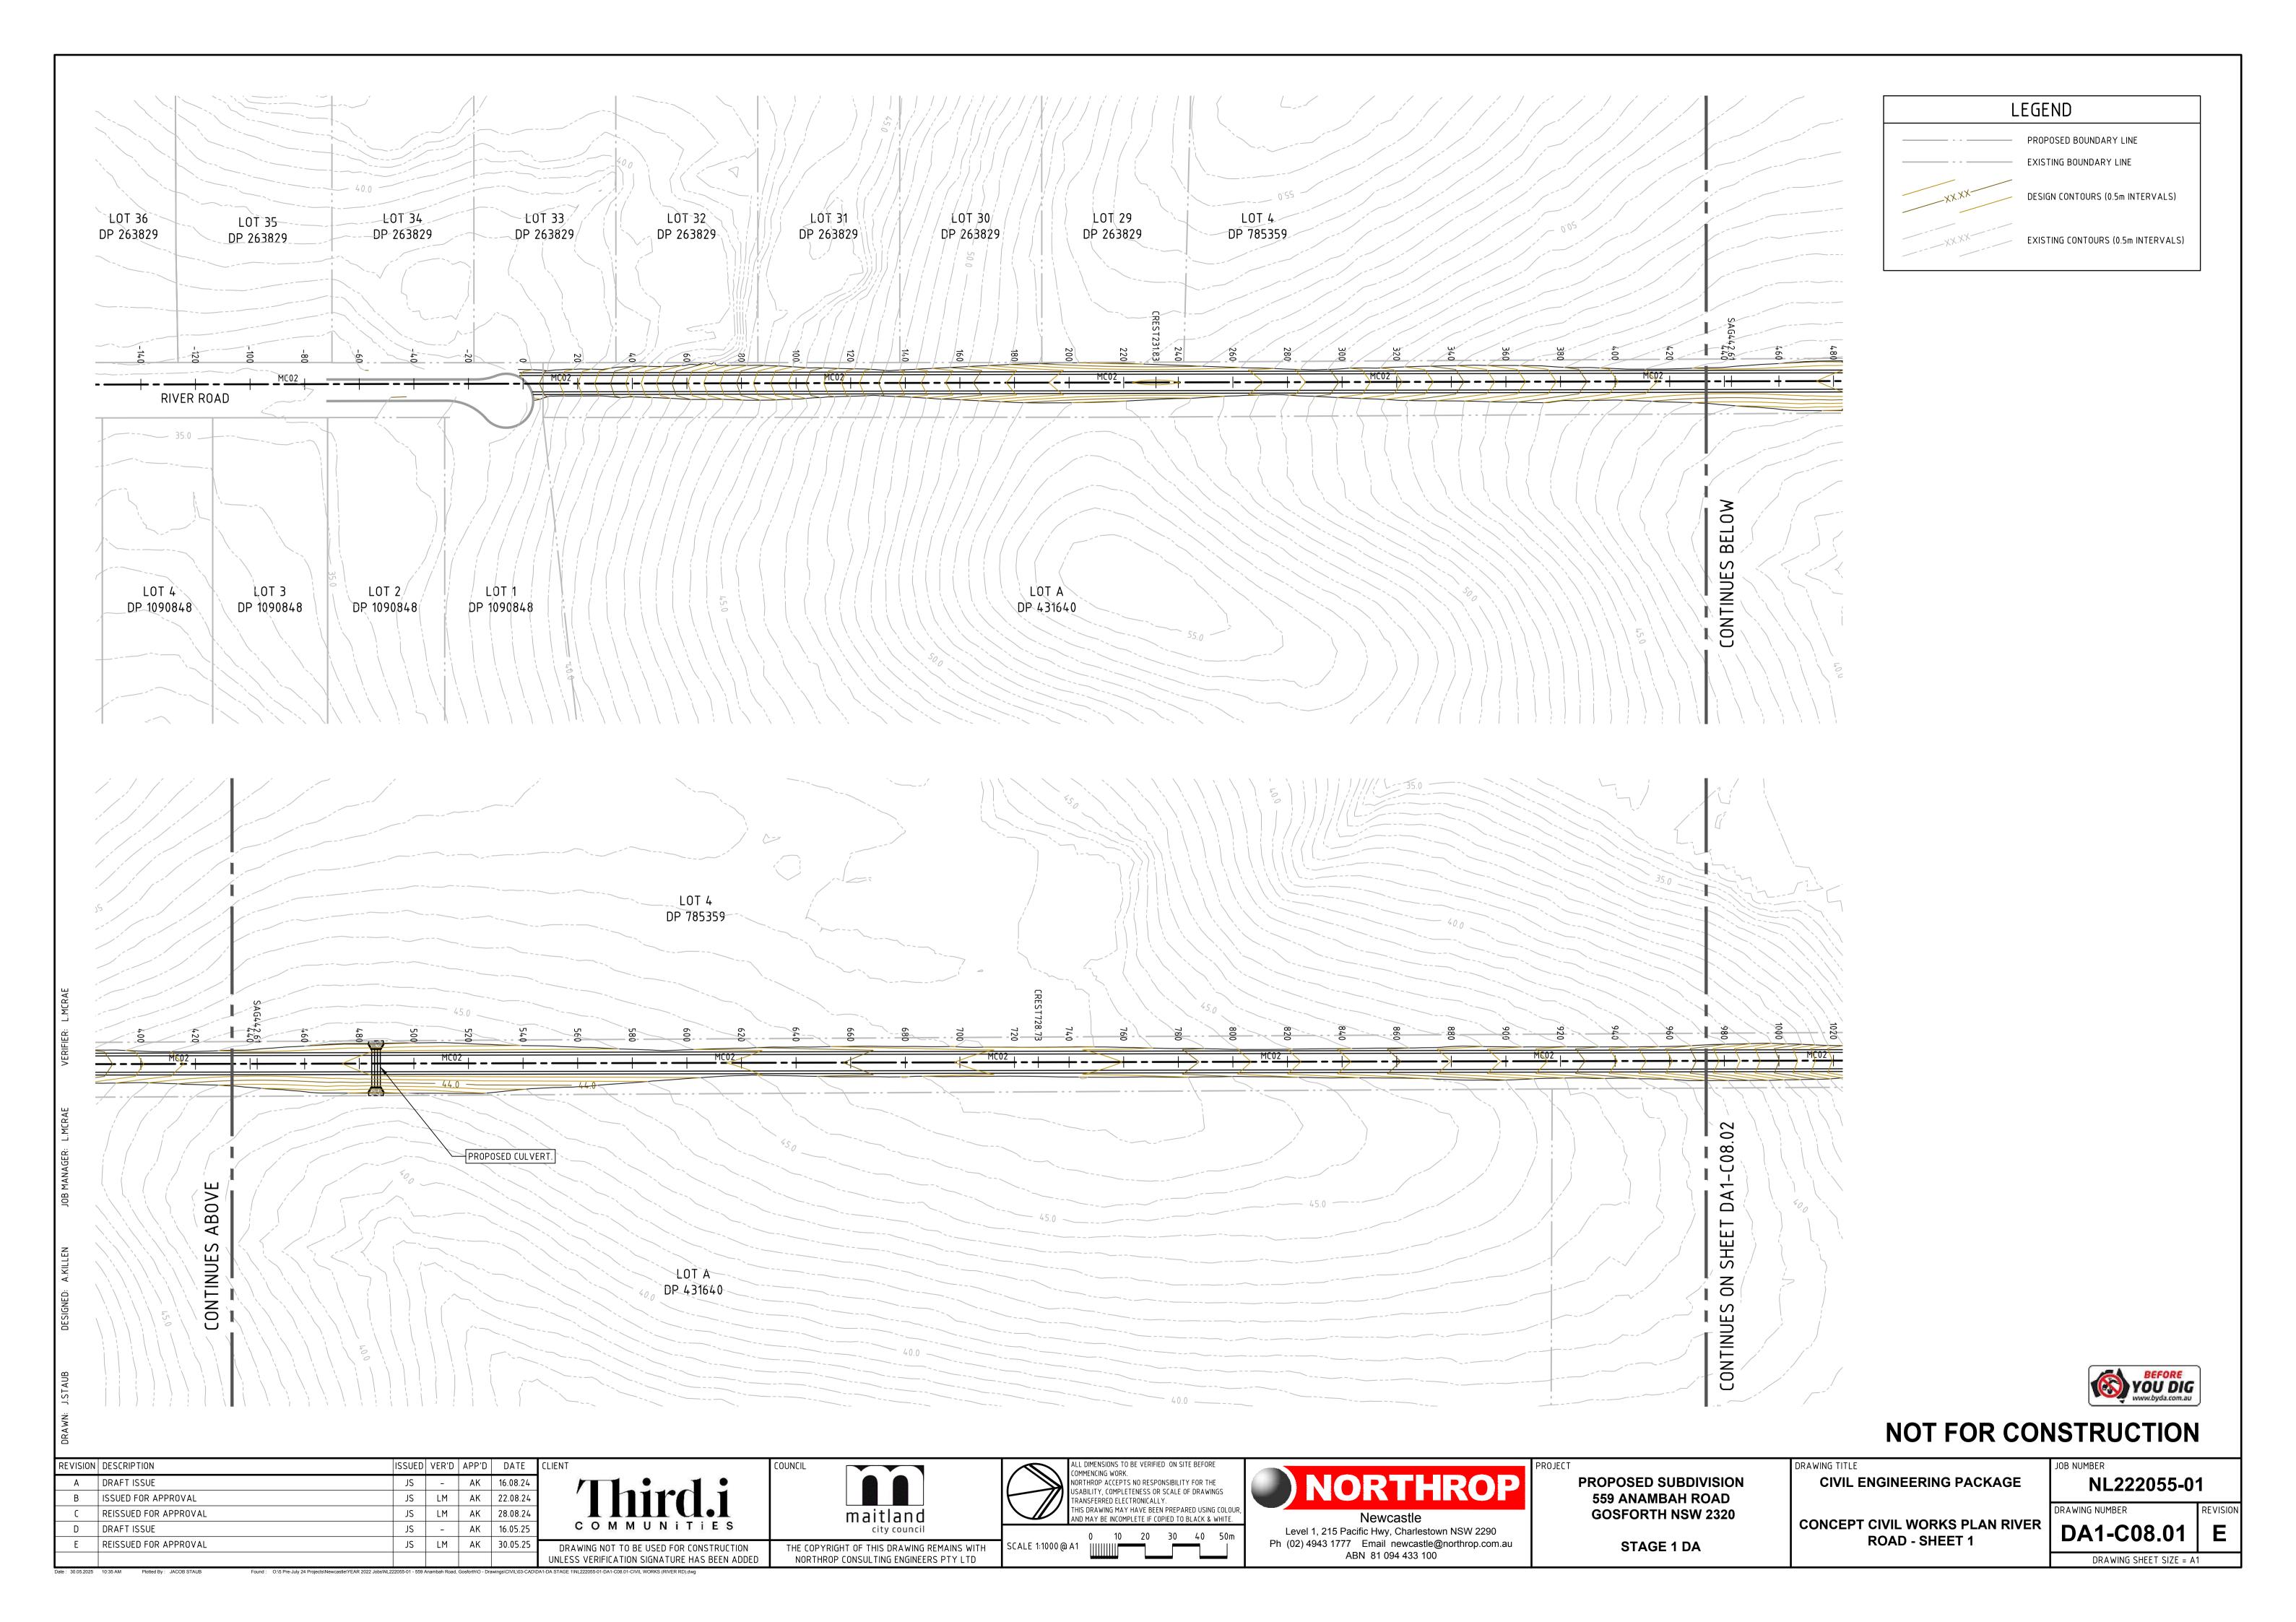
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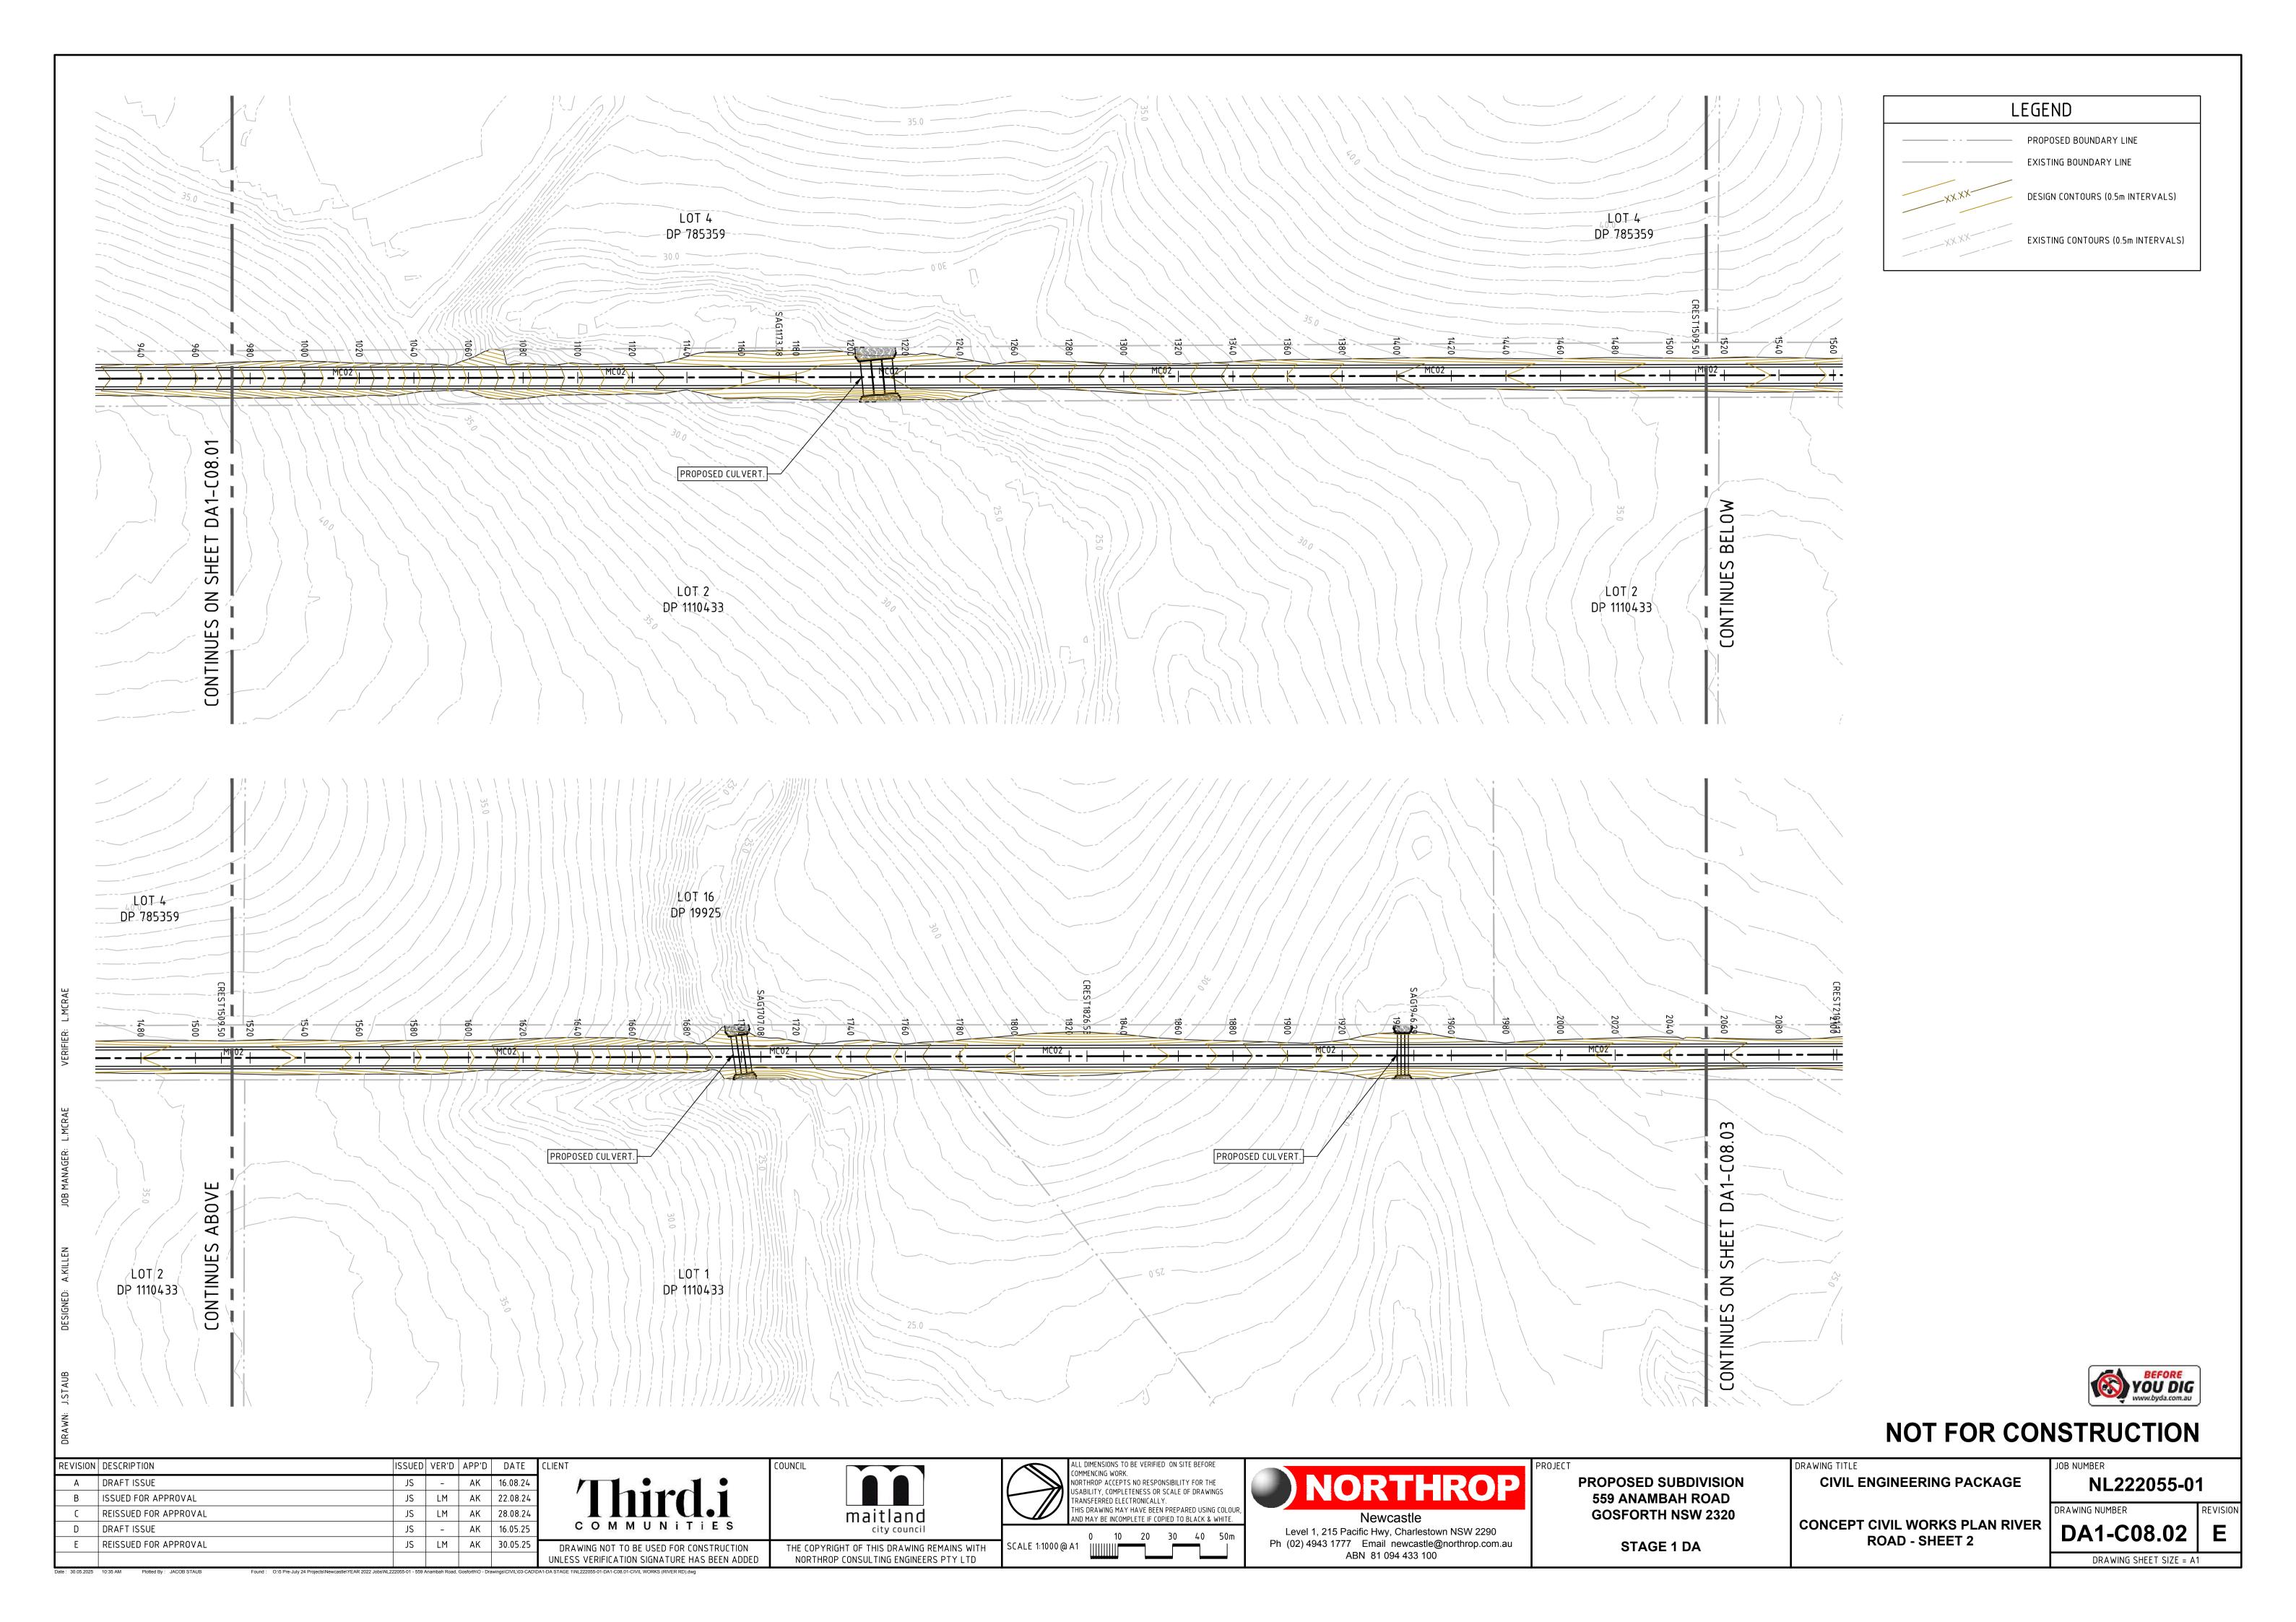
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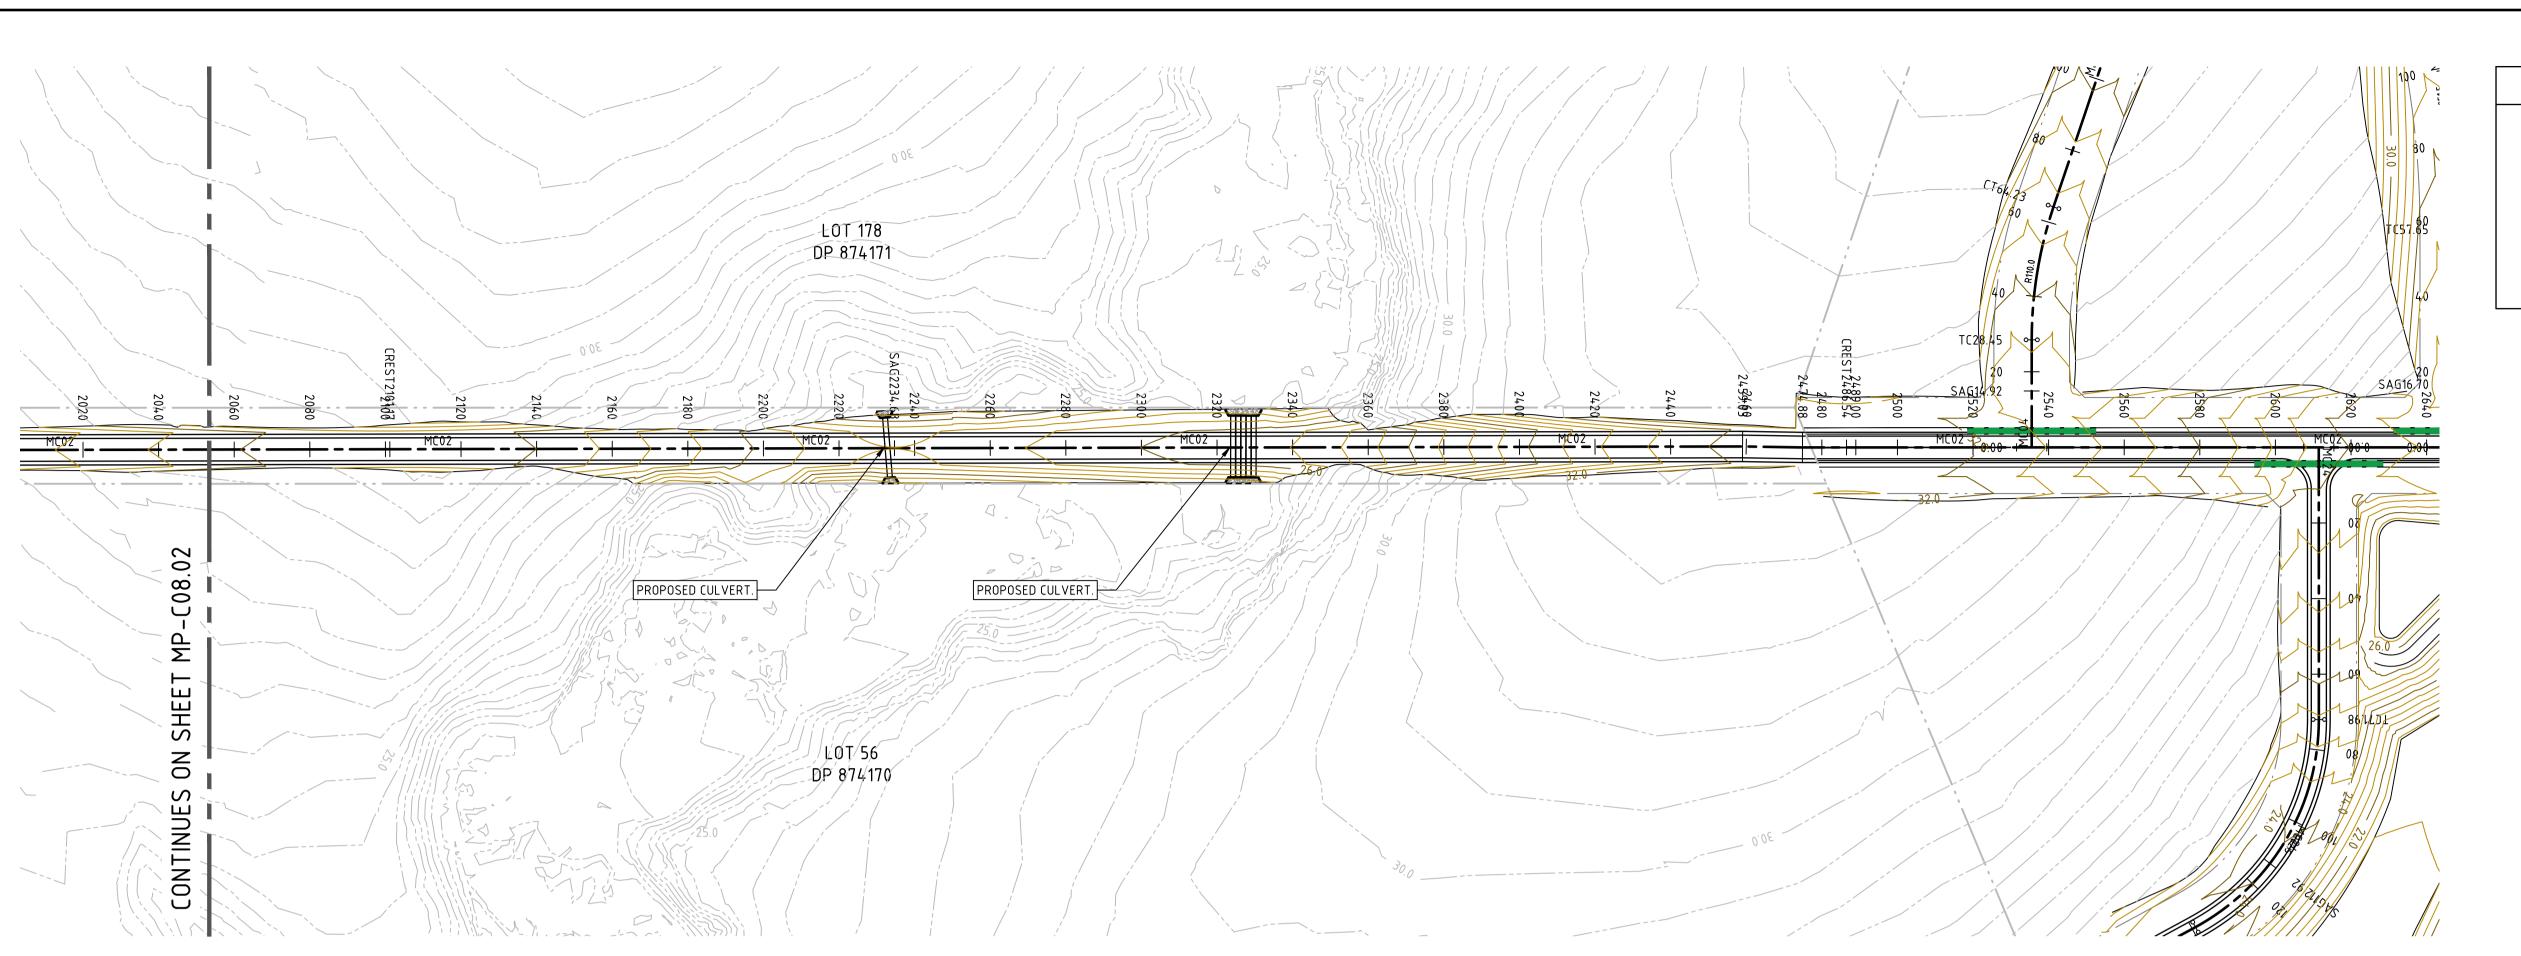
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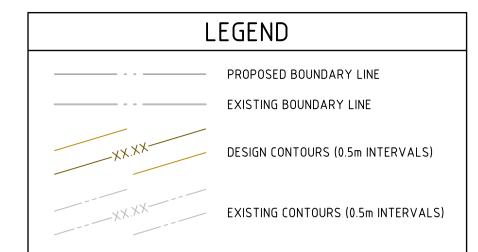
Level 1, 215 Pacific Hwy, Charlestown NSW 2290 Ph (02) 4943 1777 Email newcastle@northrop.com.au

STAGE 1 DA












REVISION	DESCRIPTION	ISSUED	VER'D	APP'D	DATE	C
Α	DRAFT ISSUE	JS	-	AK	16.08.24]
В	ISSUED FOR APPROVAL	JS	LM	AK	22.08.24	
С	REISSUED FOR APPROVAL	JS	LM	AK	28.08.24	
D	DRAFT ISSUE	JS	-	AK	16.05.25	
E	REISSUED FOR APPROVAL	JS	LM	AK	30.05.25	r
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Third.i DRAWING NOT TO BE USED FOR CONSTRUCTION maitland city council



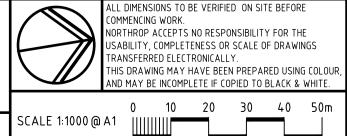

PROPOSED SUBDIVISION **559 ANAMBAH ROAD GOSFORTH NSW 2320**

STAGE 1 DA

CIVIL ENGINEERING PACKAGE

CONCEPT CIVIL WORKS PLAN RIVER **ROAD - SHEET 3**

NL222055-01 DRAWING NUMBER

DA1-C08.03 DRAWING SHEET SIZE = A1

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SCALE 1:50@ A1

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ABN 81 094 433 100

B ISSUED FOR APPROVAL

D REISSUED FOR APPROVAL

C DRAFT ISSUE

JS LM AK 22.08.24

JS - AK 16.05.25

JS | LM | AK | 30.05.25


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PROPOSED SUBDIVISION 559 ANAMBAH ROAD	CIVIL ENGINEERING PACKAGE	NL222055-0	1	
GOSFORTH NSW 2320	ROAD TYPICAL SECTIONS RIVER ROAD	DRAWING NUMBER	REVISION	
STAGE 1 DA		DA1-C08.21	D	
		DRAWING SHEET SIZE = A1		



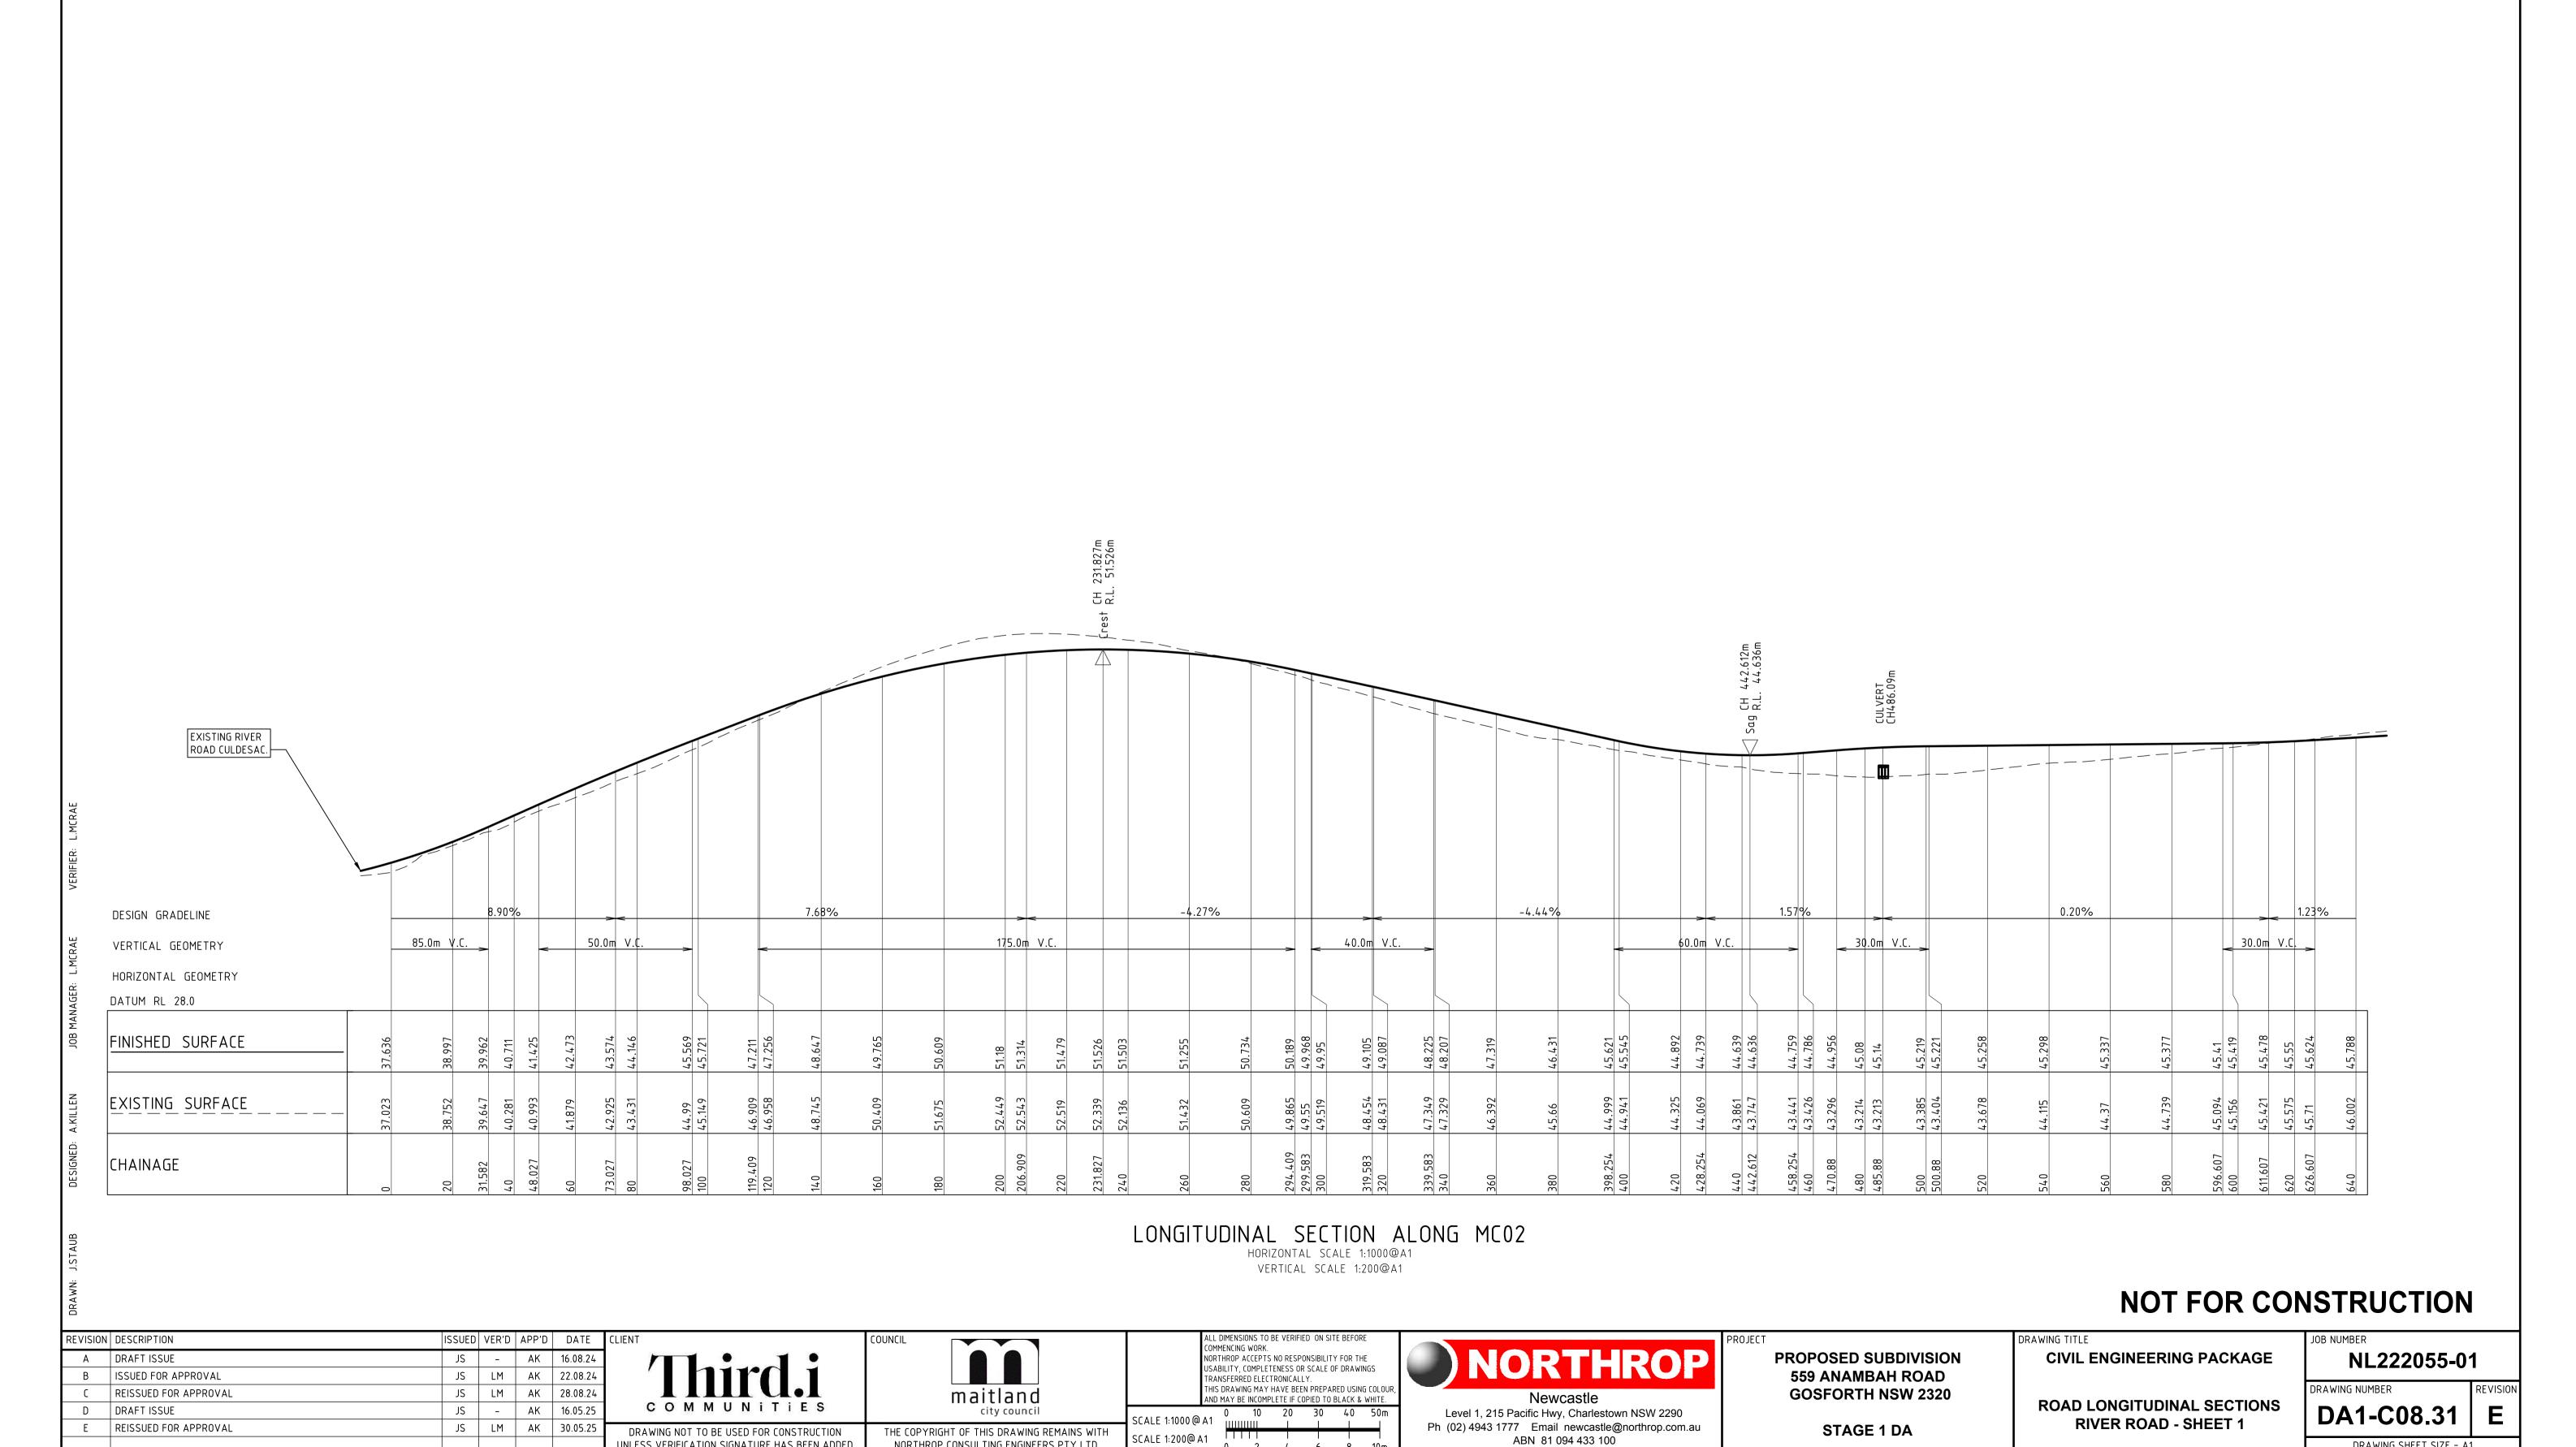DRAWING SHEET SIZE = A1

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